
NOT FOR CONSTRUCTIO


H-767 PROPOSED SUBDIVISION PLAN ISSUED MARCH

JASPER'S CORNER SUBDIVISION PLAN ONE HOME BUILDERS, LLC TAX MAP 2, LOT 20

LOCATION MAP

CIVIL ENGINEERS:

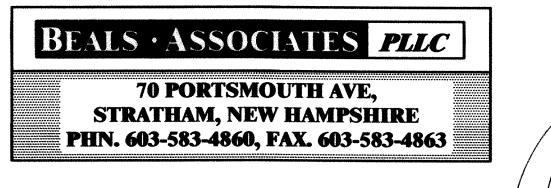

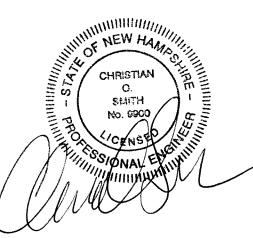


LAND SURVEYORS:

M ceneaney S urvey A ssociates, inc.

P.O. Box 681 - 24 CHESTNUT STREET DOVER, NH 03820 (603) 742-0911

WETLAND / SOIL CONSULTANT:

CAREX ECOSCIENCES
2 WASHINGTON STREET
DOVER,NH 03820
1-603-742-6665

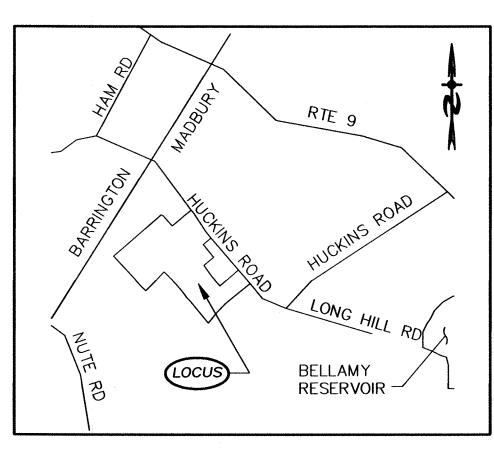

MADBURY N.H. NOT TO SCALE

PLAN SET LEGEND

5/8" REBAR	•	OVERHEAD ELEC. LINE	
DRILL HOLE	•	FENCING	X
CONC. BOUND	0	DRAINAGE LINE	——D ———D ——
UTILITY POLE	ω	SEWER LINE	S
DRAIN MANHOLE		GAS LINE	Ğ
EXISTING LIGHT POLE	\$	WATER LINE	W
EXISTING CATCH BASIN		STONE WALL	· ************************************
PROPOSED CATCH BASIN	Alle.	TREE LINE	. ~ .
PINES, ETC.	*	ABUT. PROPERTY LINES	
MAPLES, ETC.	E Company of the Comp	EXIST. PROPERTY LINES	
EXIST. SPOT GRADE	96x69	BUILDING SETBACK LINES	
PROP. SPOT GRADE		EXIST. CONTOUR	
DOUBLE POST SIGN		PROP. CONTOUR	
SINGLE POST SIGN		SOIL LINES	• • • • • • • • • • • •

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- 4 P1 PLAN AND PROFILE (HUCKINS)
- 5 P2 PLAN AND PROFILE (PROPOSED ROAD)
- 6 X1 CROSS SECTIONS (HUCKINS)
- 7 X2 CROSS SECTIONS (PROPOSED ROAD)
- 8 X3 CROSS SECTIONS (PROPOSED ROAD)
- 9 CONSTRUCTION DETAIL SHEET
- 10 EROSION CONTROL DETAILS

RECORD OWNER:

LOUISE ABBOTT 38 HUCKINS ROAD MADBURY, NH 03823


APPLICANT:


ONE HOME BUILDERS, LLC PO BOX 334 STRATHAM, NH 03885


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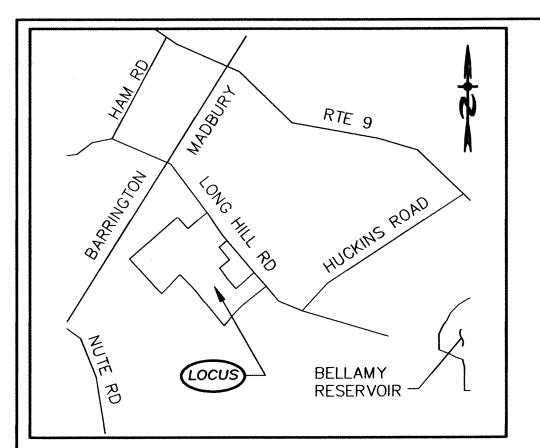
NHDES SUBDIVISION APPROVAL NUMBER:
NPDES APPROVAL NUMBER:

	REVISIONS:	DATE:
1	REVISED PER REVIEW COMMENTS	4/25/14




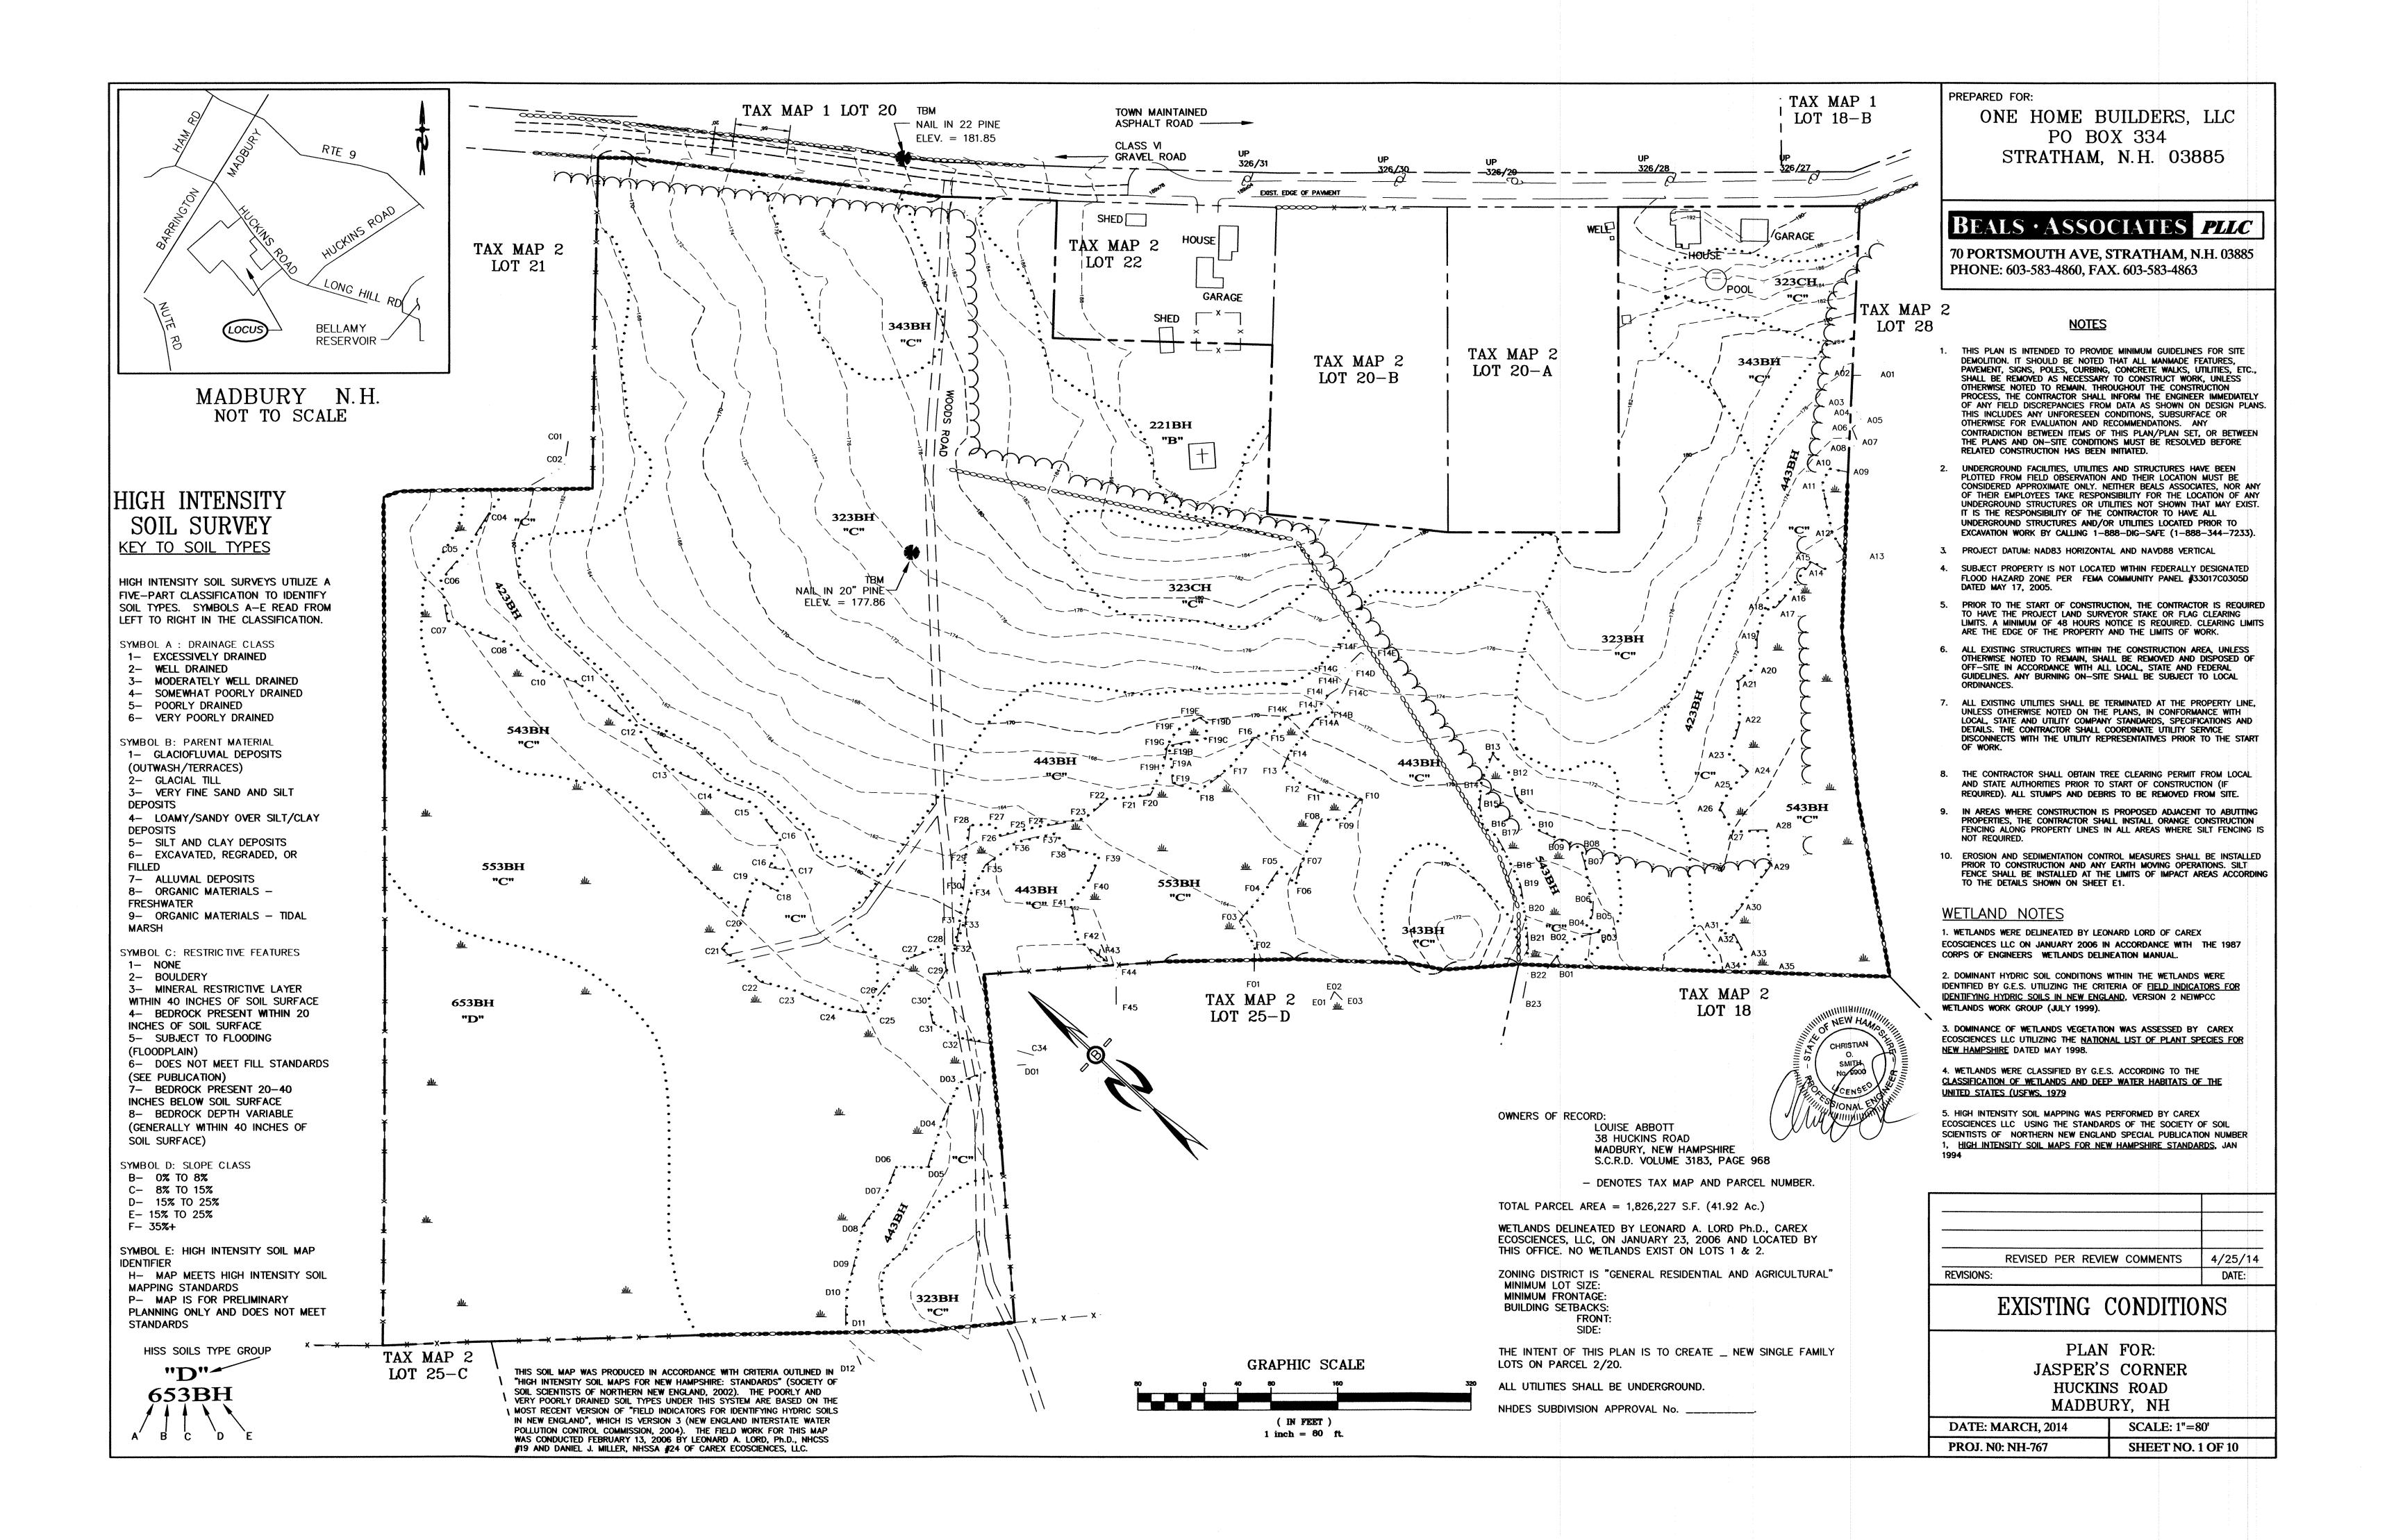

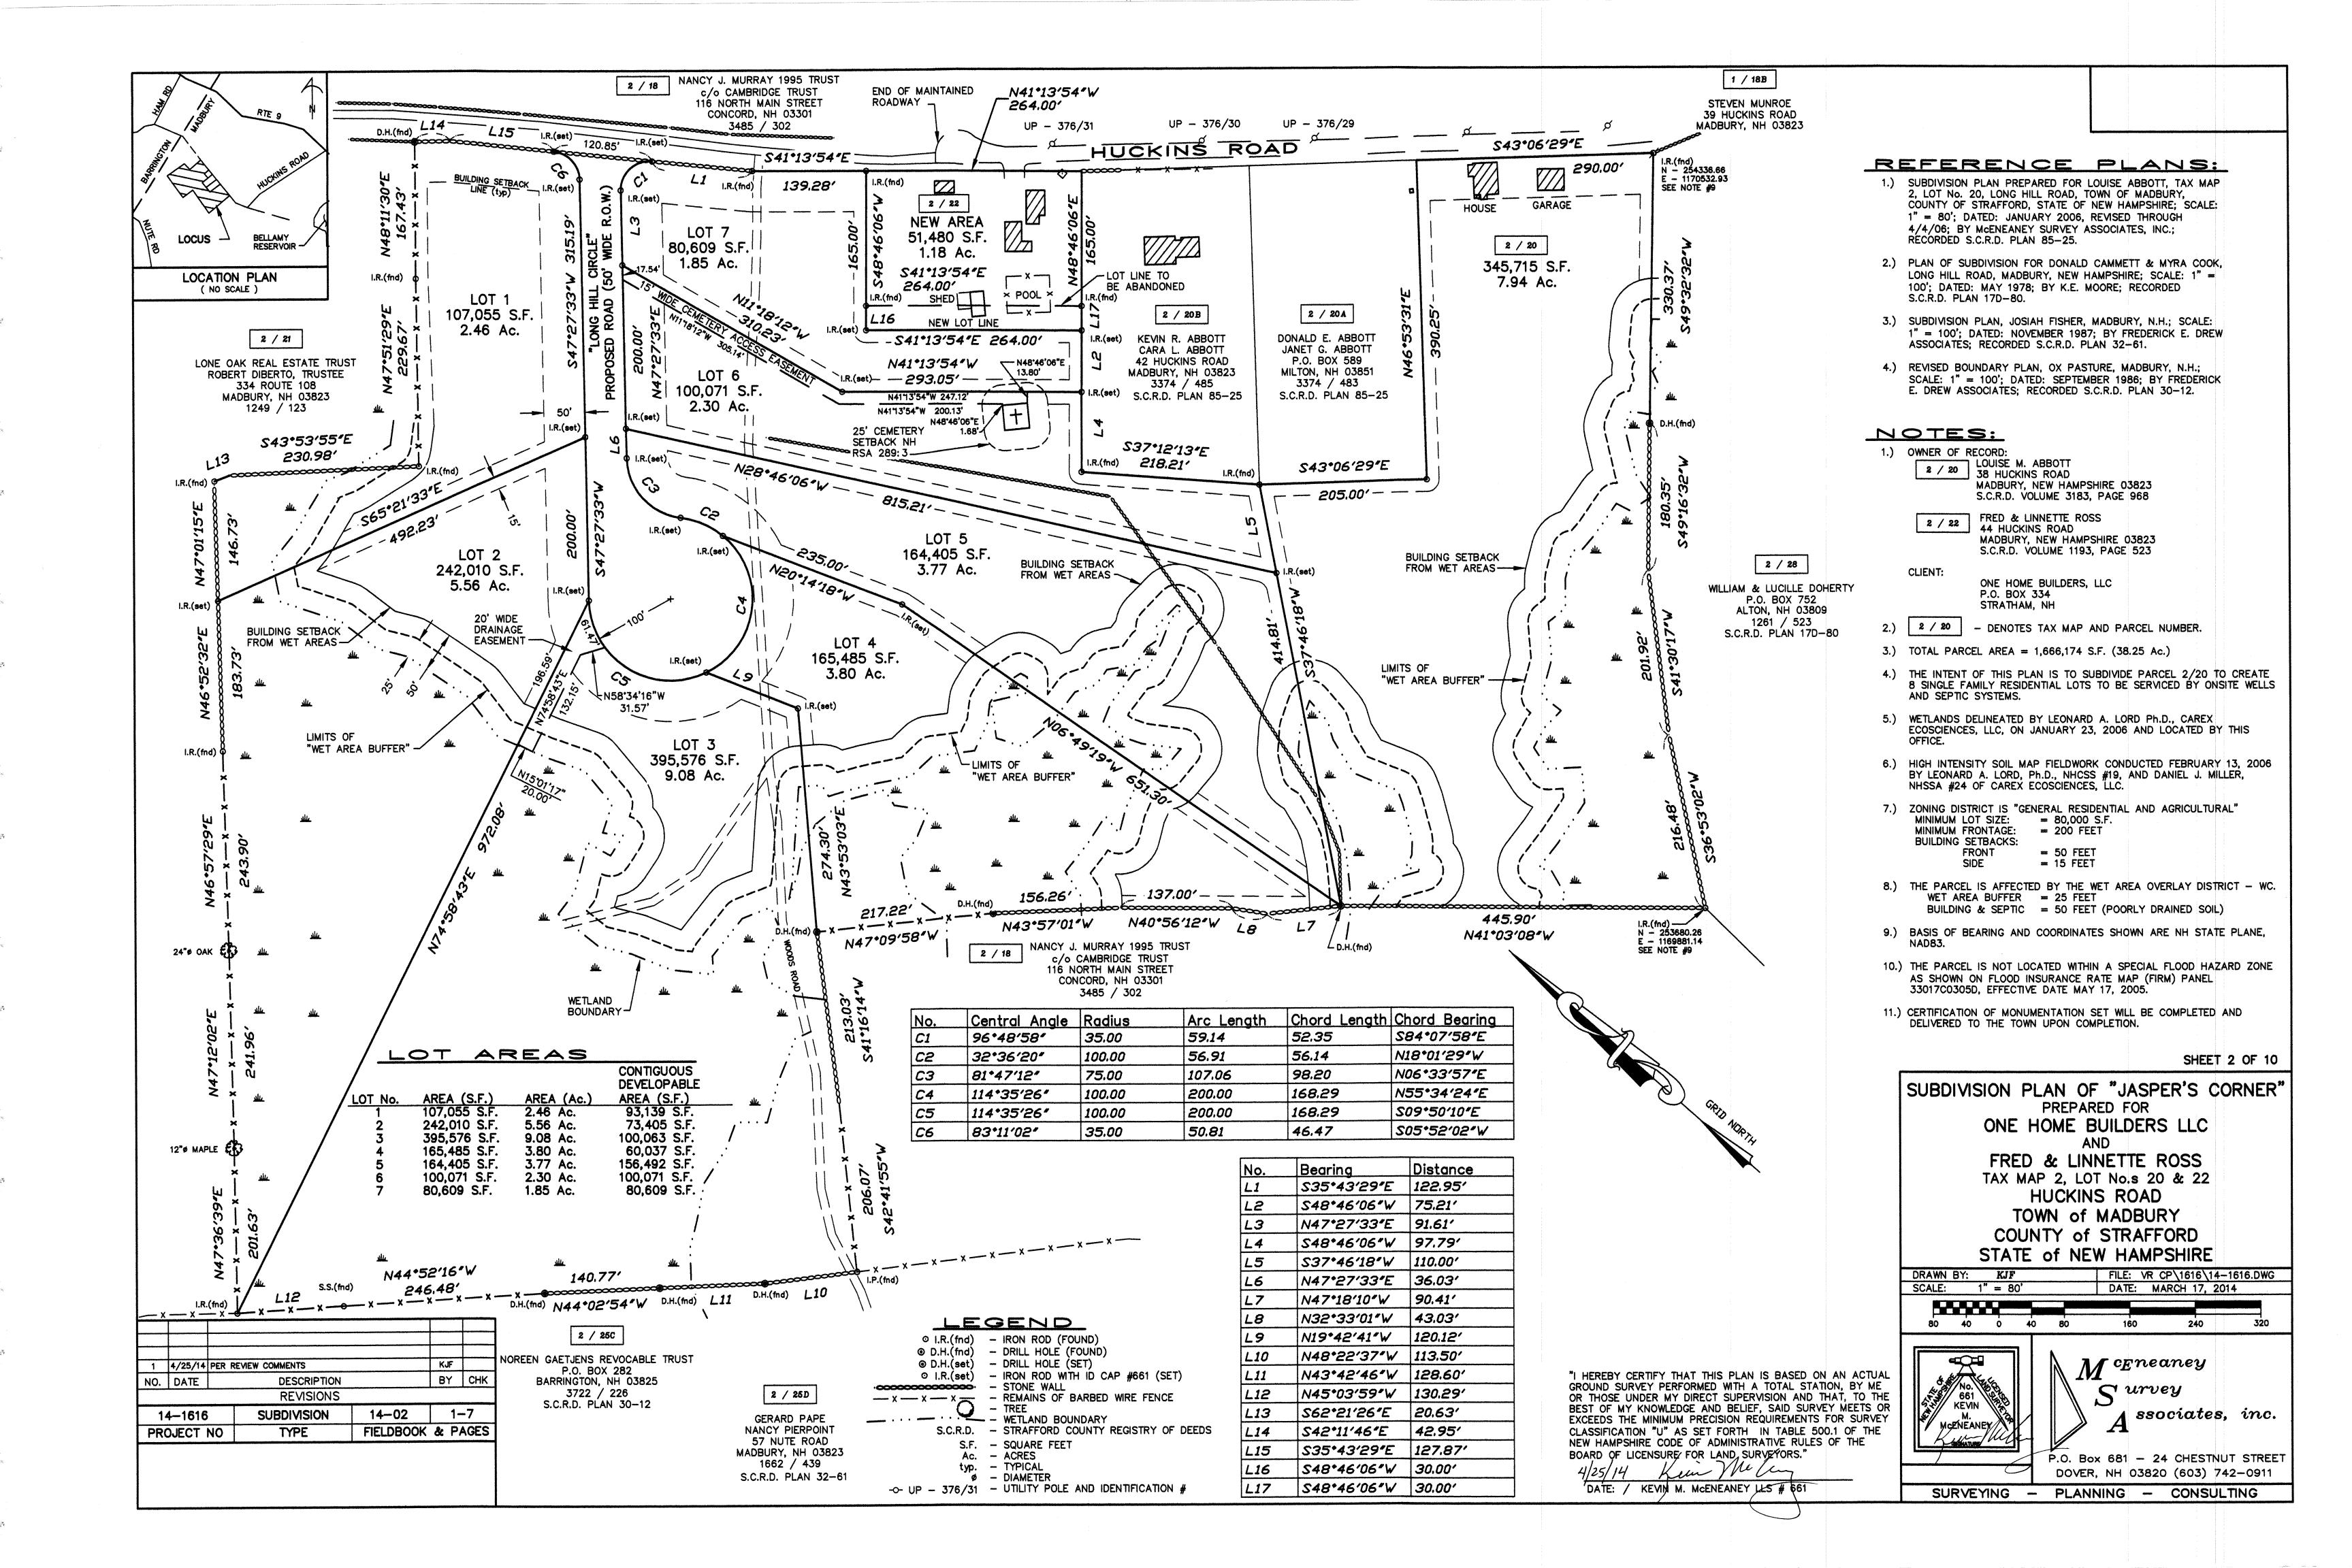

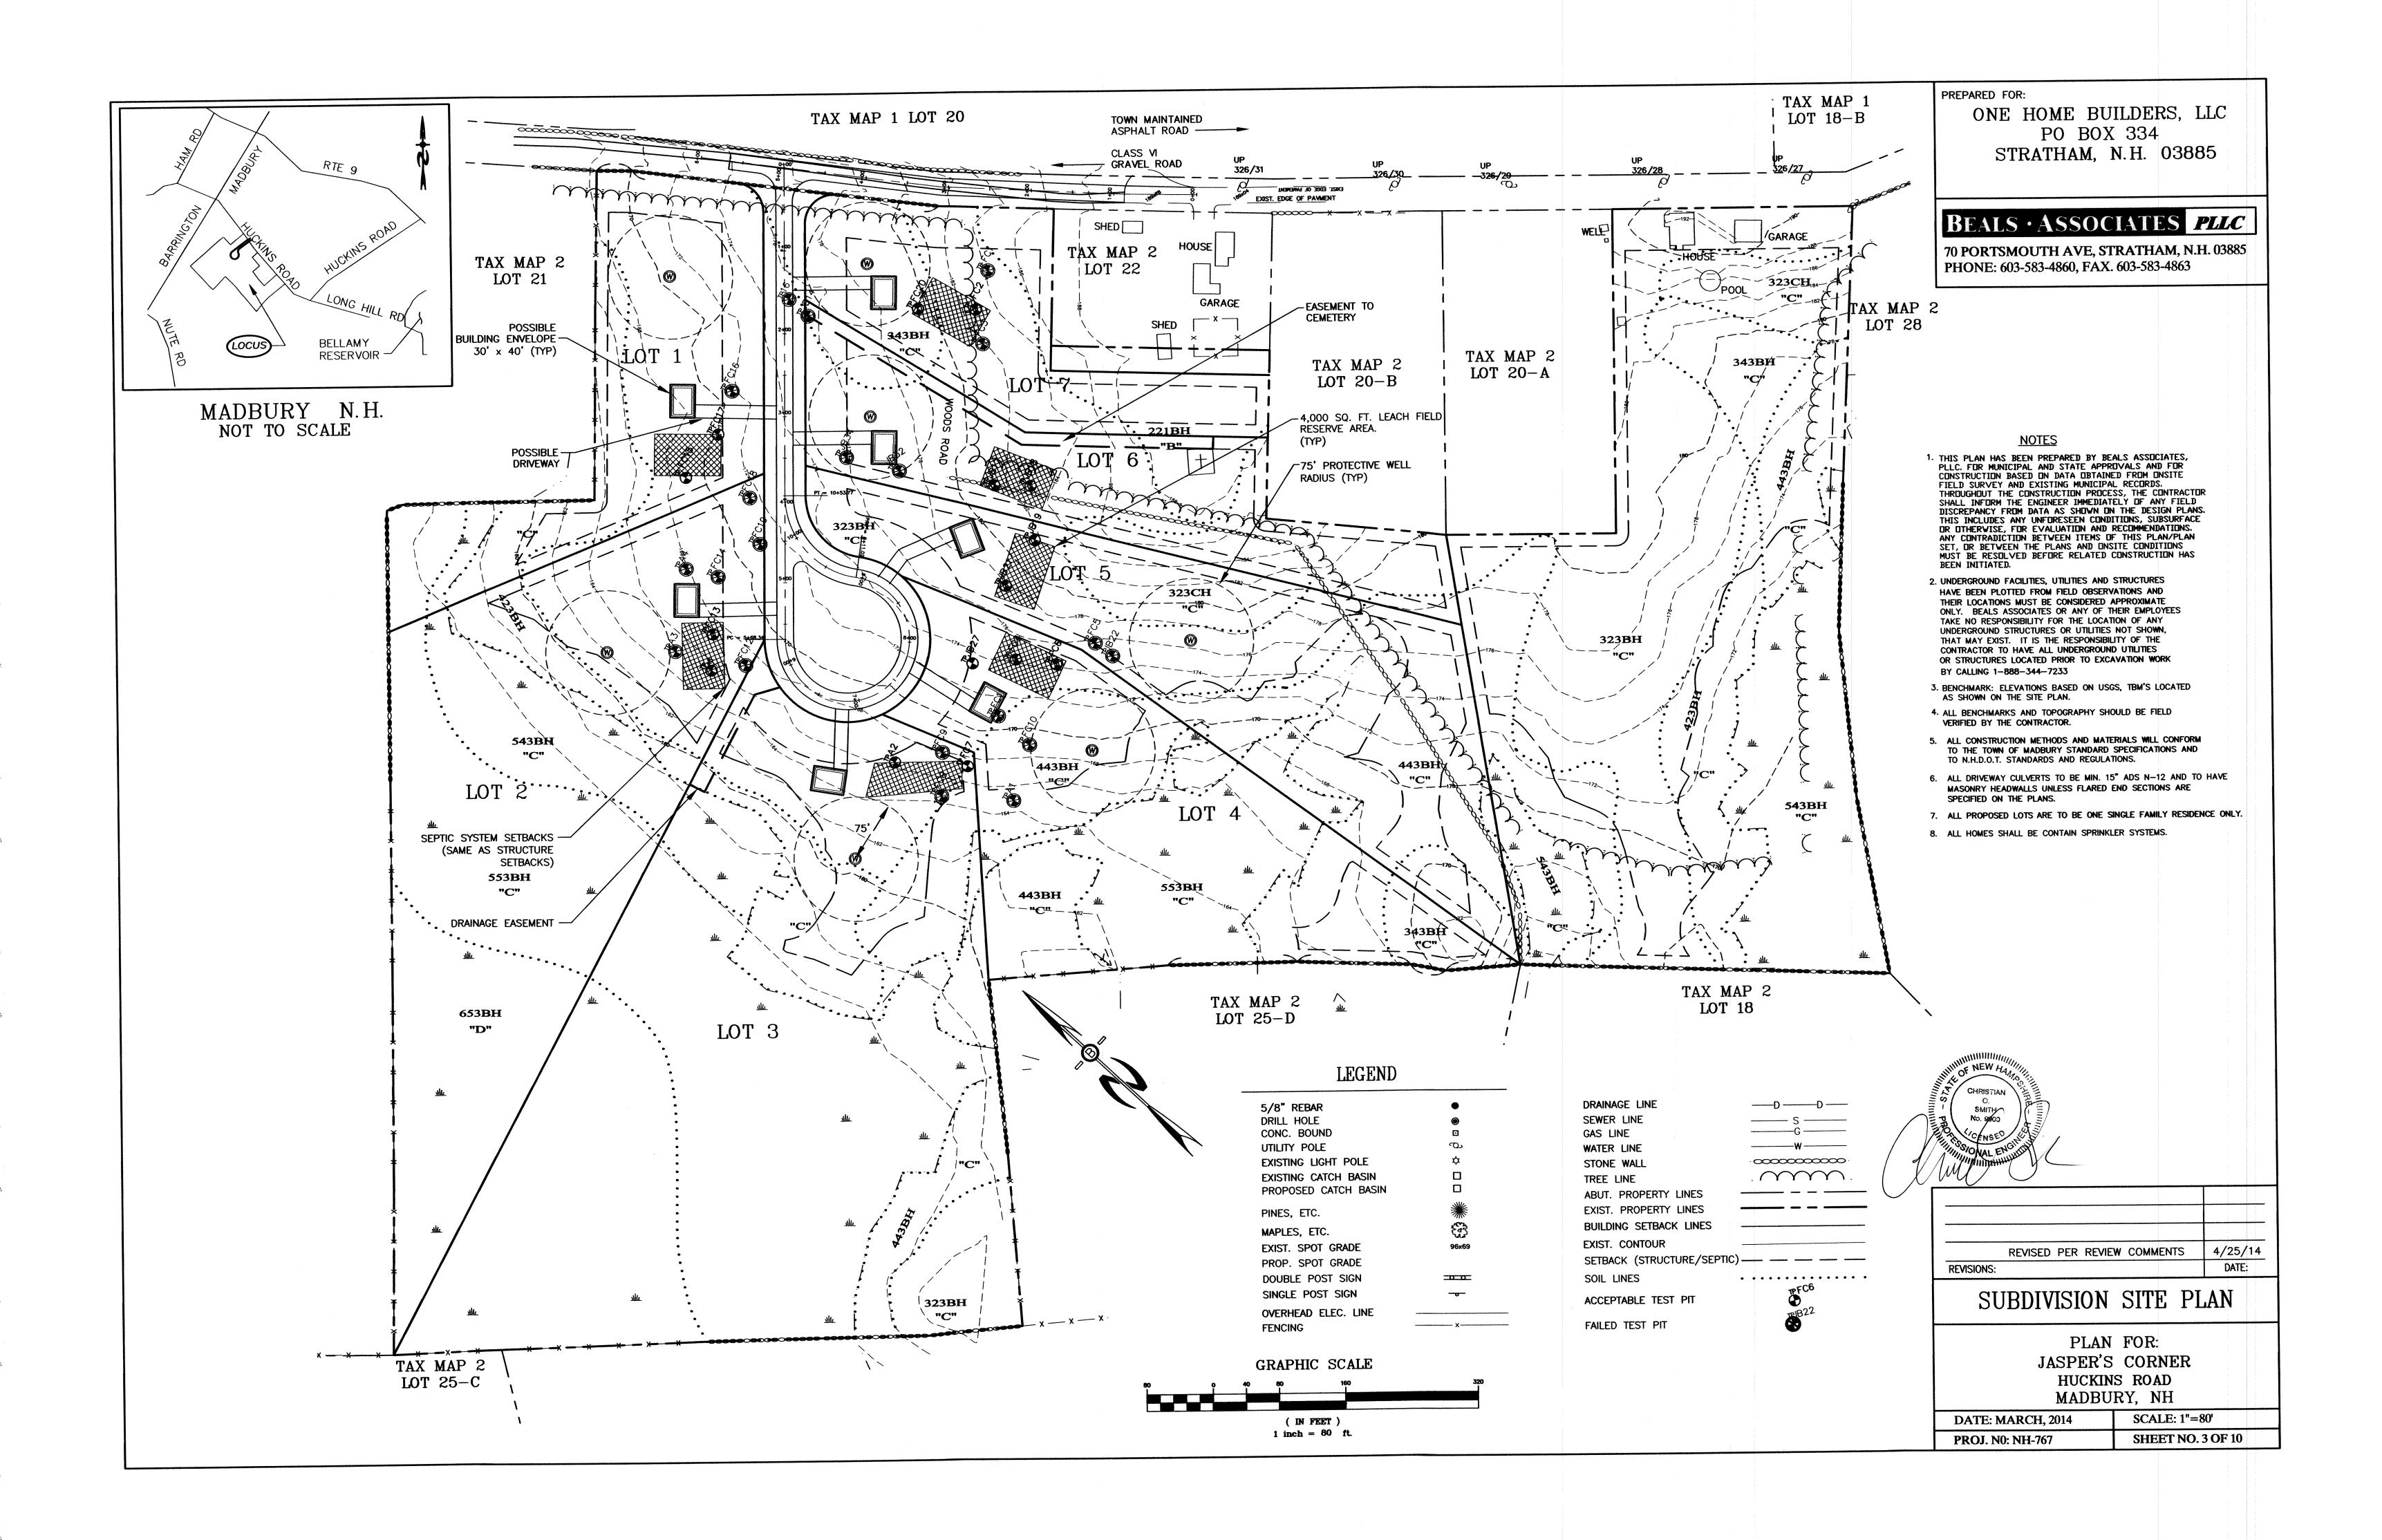


MADBURY N.H. NOT TO SCALE

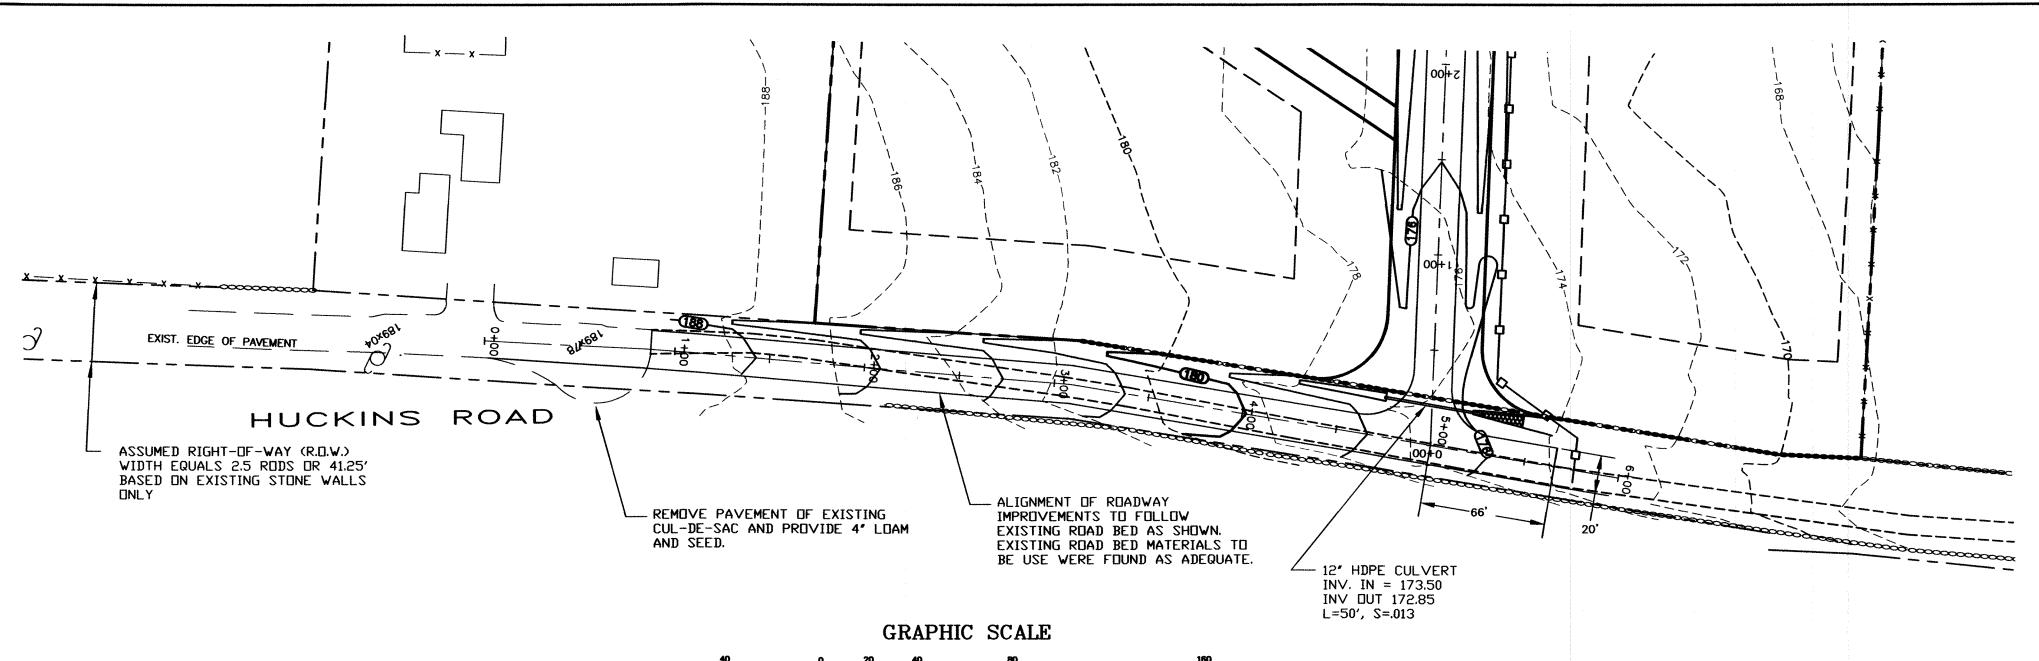

GRAPHIC SCALE

0 20 40 80 160

(IN FEET)
1 inch = 40 ft.

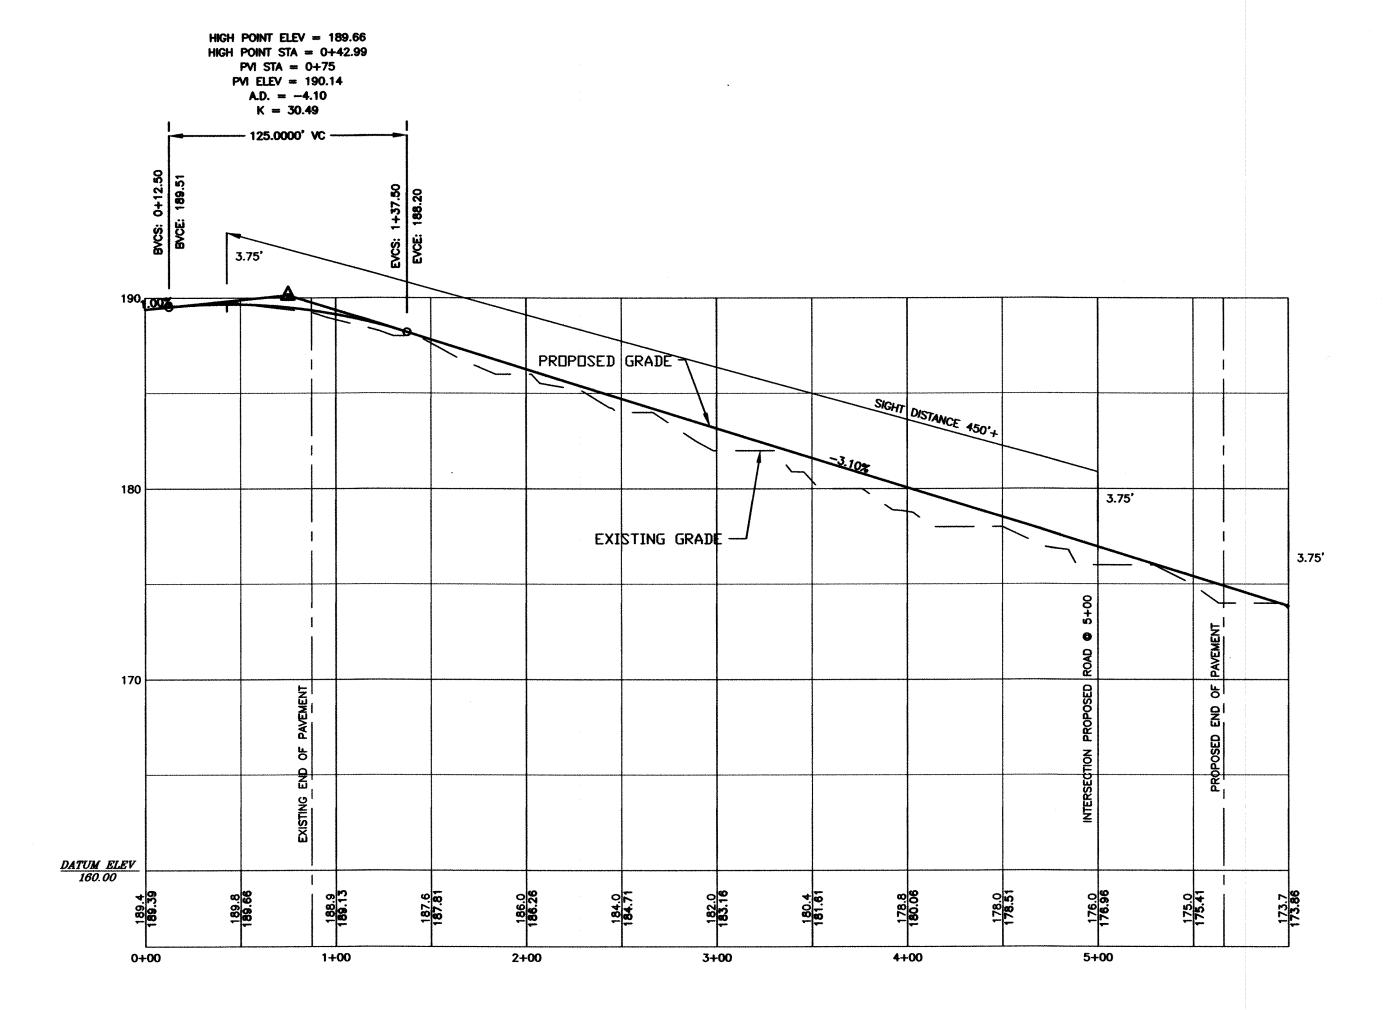


PROFILE SCALES:
HORIZONTAL: 1"=40' VERTICAL: 1"=4'

PREPARED FOR:

ONE HOME BUILDERS, LLC
PO BOX 334
STRATHAM, N.H. 03885

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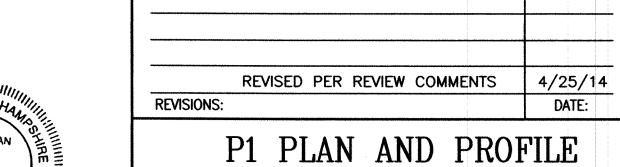
70 PORTSMOUTH AVE, STRATHAM, N.H. 03885 PHONE: 603-583-4860, FAX. 603-583-4863

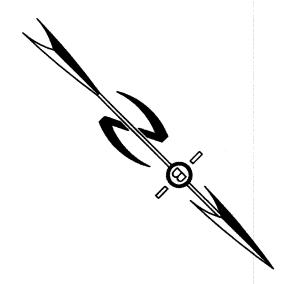

CONSTRUCTION NOTES


- 1. SILTATION/ EROSION CONTROLS SHALL BE INSTALLED PRIOR TO CONSTRUCTION, SHALL BE MAINTAINED DURING CONSTRUCTION, AND SHALL REMAIN UNTIL SITE HAS BEEN STABILIZED WITH PERMANENT VEGETATION. SEE DETAIL SHEET FOR ADDITIONAL NOTES ON EROSION CONTROL.
- 2. ALL DISTURBED AREAS NOT TO FINAL GRADE BY MID-NOVEMBER SHALL BE SEEDED WITH WINTER RYE OR ACCEPTABLE SUBSTITUTE AND MULCHED TO PROVIDE VEGETATION COVER.
- 3. FINAL DRAINAGE, GRADING AND EROSION PROTECTION MEASURES SHALL CONFORM TO REGULATIONS OF THE SUBDIVISION REGULATIONS.
- 4. ALL ROAD AND DRAINAGE WORK TO BE DONE IN CONFORMANCE WITH TOWN REGULATIONS AND NHDOT SPECIFICATIONS, WHICHEVER IS MORE STRINGENT.
- 5. CONTRACTOR TO VERIFY EXISTING UTILITIES AND TO NOTIFY ENGINEER OF ANY DISCREPANCY IMMEDIATELY.
- 6. ALL UTILITIES SHALL BE INSTALLED UNDERGROUND IN ACCORDANCE WITH REGULATIONS AND SPECIFICATIONS AS APPROVED BY THE APPROPRIATE UTILITY COMPANY. LOW PROFILE STRUCTURES SHALL BE USED TO THE GREATEST EXTENT POSSIBLE.
- 7. ALL BENCHMARKS AND TOPOGRAPHY SHOULD BE FIELD VERIFIED BY THE CONTRACTOR. ENGINEER TO BE NOTIFIED IMMEDIATELY OF ANY DISCREPANCY.


HUCKINS ROAD



PLAN FOR:
JASPER'S CORNER
HUCKINS ROAD
MADBURY, NH

DATE: MARCH, 2014	SCALE: AS SHOWN		
PROJ. N0: NH-767	SHEET NO. 4 OF 10		

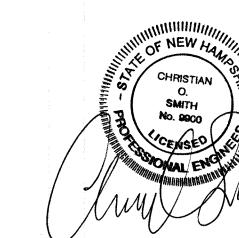

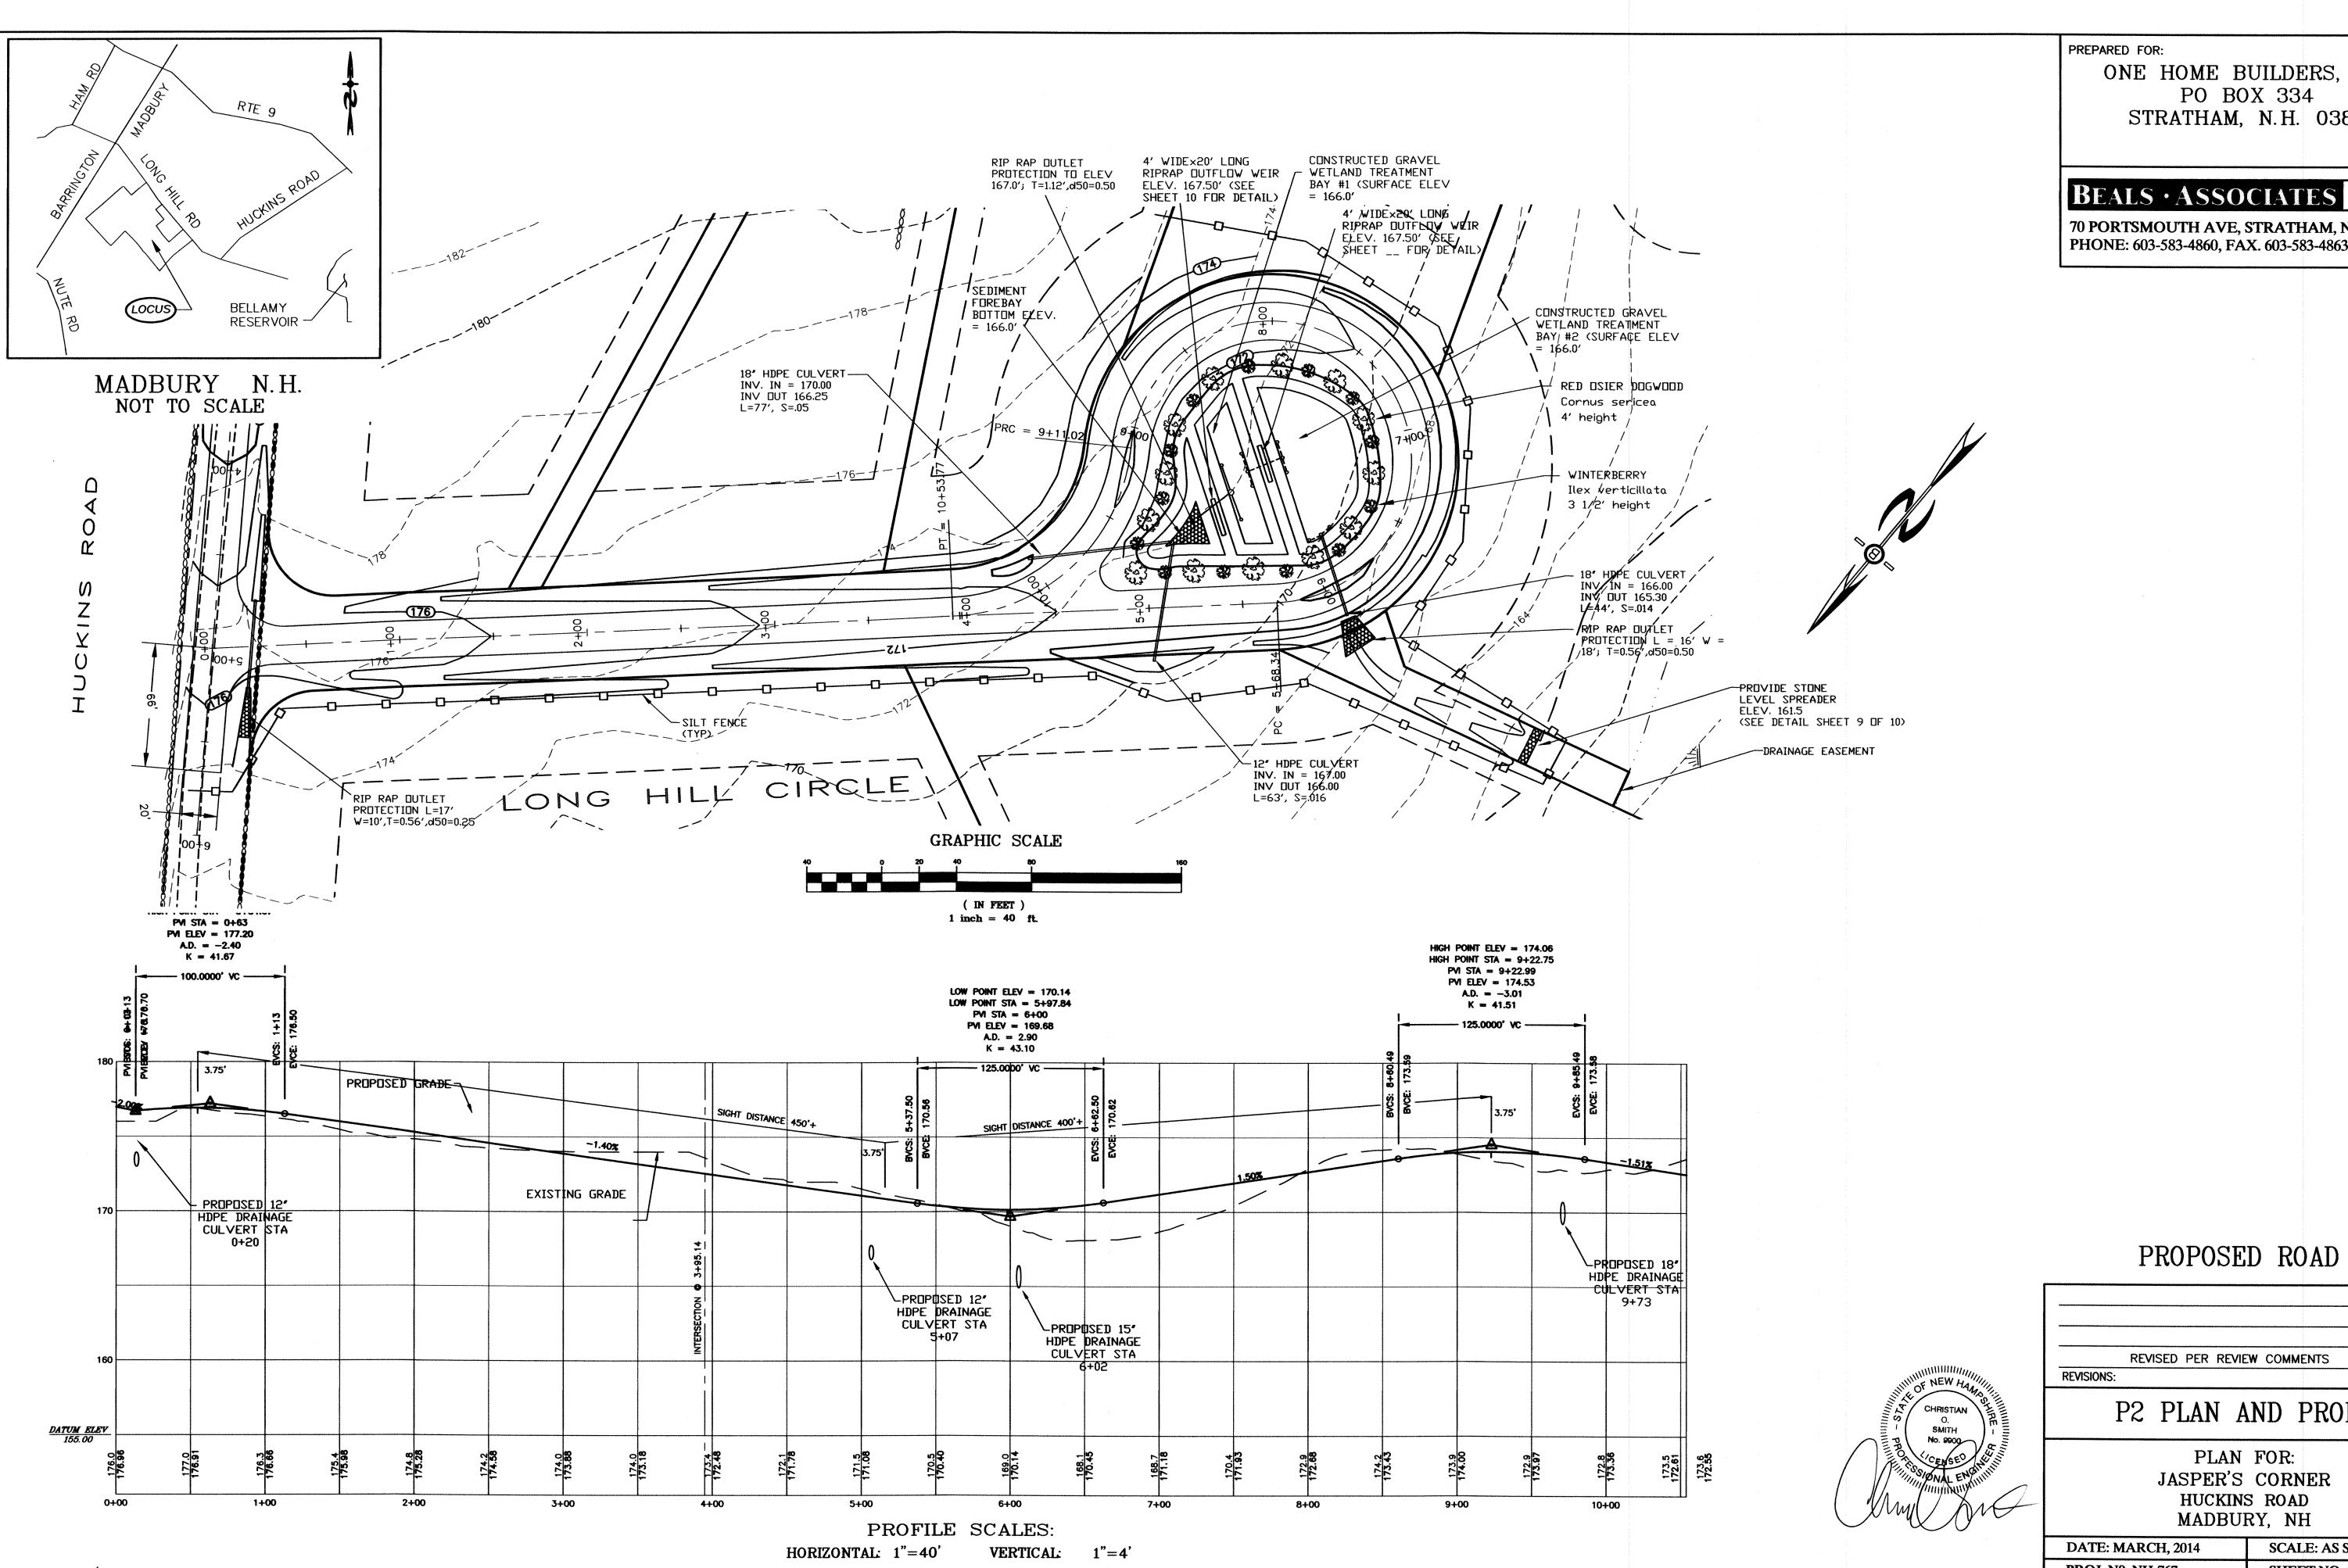

ONE HOME BUILDERS, LLC PO BOX 334 STRATHAM, N.H. 03885

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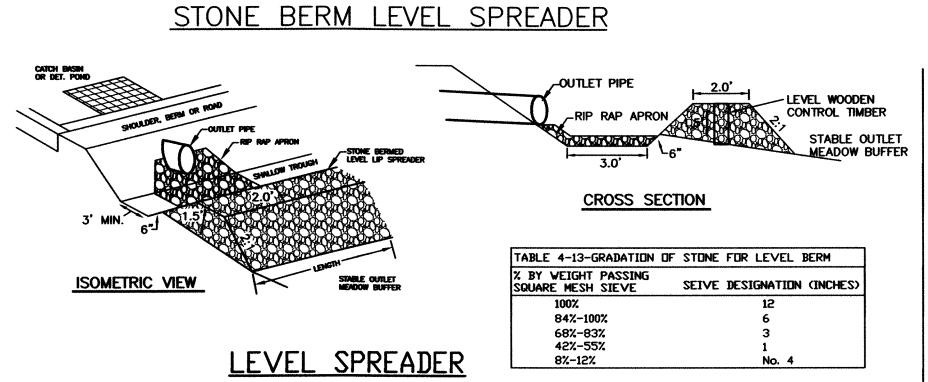
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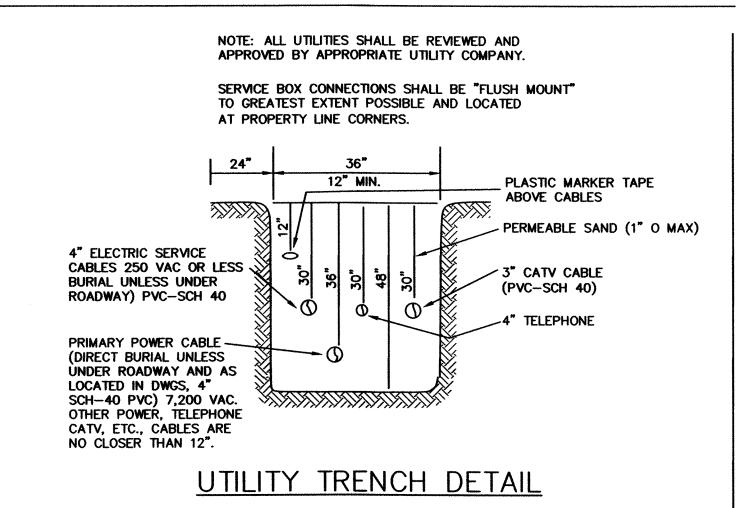
P2 PLAN AND PROFILE


PLAN FOR: JASPER'S CORNER HUCKINS ROAD MADBURY, NH

DATE: MARCH, 2014	SCALE: AS SHOWN		
PROJ. N0: NH-767	SHEET NO. 5 OF 10		



- 1. CONSTRUCT THE LEVEL SPREADER LIP ON A 0% GRADE TO INSURE UNIFORM SPREADING OF RUNOFF.
- 2. LEVEL SPREADER SHALL BE CONSTRUCTED ON UNDISTURBED SOIL AND NOT ON FILL.
- 3. THE ENTIRE LEVEL LIP AREA SHALL BE PROTECTED BY PLACING EXCELSIOR ENFORCER MATTING BENEATH THE STONE. EACH STRIP SHALL OVERLAP BY AT LEAST SIX INCHES.
- 4. THE FLOW FROM THE LEVEL SPREADER SHALL OUTLET ONTO STABILIZED AREAS. WATER SHOULD NOT RE-CONCENTRATE IMMEDIATELY BELOW THE SPREADER.
- 5. MAINTENANCE: THE LEVEL SPREADER SHOULD BE CHECKED PERIODICALLY AND AFTER EVERY MAJOR STORM TO DETERMINE IF THE LIP HAS BEEN DAMAGED AND THE DESIGN CONDITIONS HAVE NOT CHANGED. ANY DETRIMENTAL SEDIMENT ACCUMULATION SHOULD BE REMOVED. IF STONE REMOVAL HAS TAKEN PLACE ON THE LIP, THEN THE DAMAGE SHOULD BE REPAIRED.




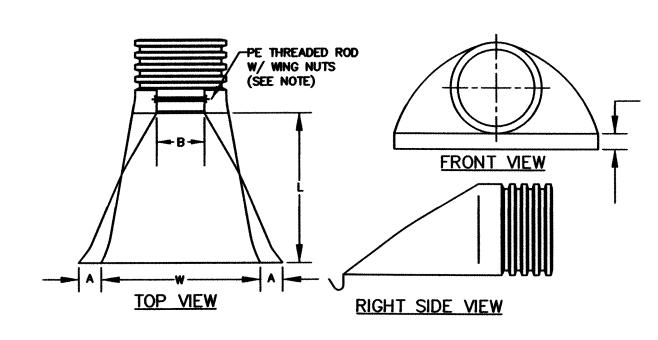


PART No.	PIPE SIZE	A	B(MAX)	Н	L	w
1510-NP	15"	6.5"	10"	6.5"	25"	29"
	375 mm	165 mm	254 mm	165 mm	635 mm	735 mm
1810-NP	18"	7.5 "	15"	6.5"	32**	35 *
	450 mm	190 mm	380 mm	165 mm	812 mm	890 mm
2410-NP	24"	7.5"	18"	6.5"	36"	45"
	600 mm	190 mm	450 mm	165 mm	900 mm	1140 mm
3010-NP	30" 750 mm	10.5* 266 mm	N/A	7.0 ° 178 mm	53 * 1345 mm	68 * 1725 mm
3610-NP	36" 900 mm	10.5" 266 mm	N/A	7.0" 178 mm	53" 1345 mm	68" 1725 mm

NOTE: PE THREADED ROD W/ WING NUTS PROVIDED FOR END SECTIONS 15"-24". 30" & 36" END SECTIONS TO BE WELDED PER MANUFACTURER'S

ADS N-12 FLARED END SECTIONS NOT TO SCALE (ALL DIMENSIONS ARE NOMINAL)

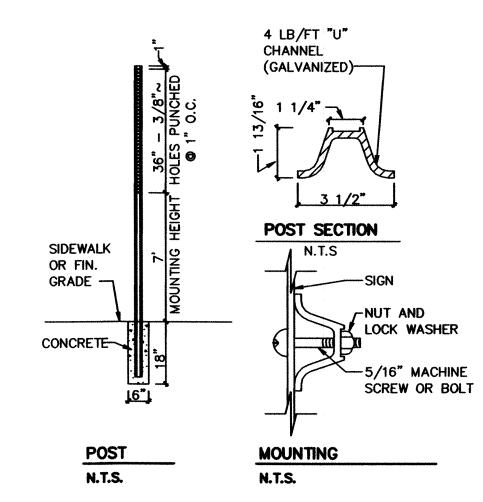

STREET SIGN DETAIL STOP SIGN (R1-1) 30" x 30" SPEED LIMIT SIGN (R2-1) 24" × 30"

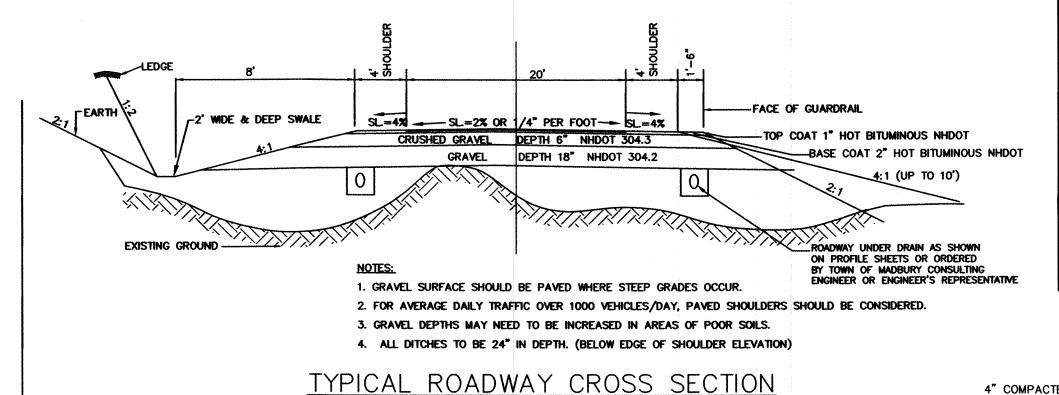


NOT TO SCALE

PREPARED FOR: ONE HOME BUILDERS, LLC STRATHAM, N.H. 03885

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PO BOX 334

70 PORTSMOUTH AVE, STRATHAM, N.H. 03885 PHONE: 603-583-4860, FAX. 603-583-4863

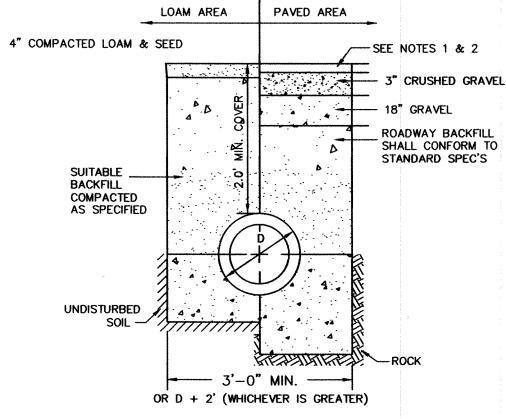

1. PAVEMENT REPAIR IN EXISTING ROADWAYS SHALL CONFORM TO STREET OPENING REGULATIONS. 2. NEW ROADWAY CONSTRUCTION SHALL CONFORM TO SUBDIVISION SPECIFICATIONS.

TYPICAL DRAINAGE TRENCH NOT TO SCALE

CONSTRUCTION CRITERIA

ROOTS, BRUSH, BOULDERS, SOD AND RUBBISH. SUBGRADE SURFACE TO BE ROLLED BEFORE PLACEMENT OF FILL MATERIAL. THE SURFACE SHALL HAVE MOISTURE ADDED OR IT SHALL BE COMPACTED IF NECESSARY SO THAT THE FIRST LAYER OF FILL MATERIAL CAN BE COMPACTED AND BONDED TO THE SUBBASE

FILL PLACEMENT: FILL SHALL BE FREE OF SOD, ROOTS, FROZEN SOIL, STONES MORE THAN 6 INCHES IN DIA., AND OTHER OBJECTIONABLE MATERIAL.

-FILL TO PLACED EQUALLY AROUND SUBSURFACE STRUCTURES & PIPES TO PREVENT DAMAGE FROM UNEQUAL LOADING. -PLACING AND SPREADING OF FILL MATERIAL SHALL BE STARTED AT SUBGRADXE ELEVATION AND BROUGHT UP IN HORIZONTAL LAYERS OF THICKNESS' ALLOWING -DISTRIBUTION AND GRADATION OF MATERIALS SHALL BE SUCH THAT NO LENSES,

POCKETS, STREAKS, OR LAYERS OF MATERIAL DIFFER SUBSTANTIALLY IN TEXTURE OF GRADATION FROM SURROUNDING MATERIAL -MAXIMUM THICKNESS OF GRAVEL LIFTS TO 1 FOOT (12 INCHES).

MOISTURE CONTROL: MOISTURE CONTENT OF THE FILL SHALL BE ADEQUATE FOR OBTAINING THE REQUIRED COMPACTION. IF THE MATERIAL IS TOO WET IT SHALL BE DRIED TO MEET THIS REQUIREMENT, IF THE MATERIAL IS TOO DRY IT SHALL HAVE WATER ADDED AND MIXED UNTIL REQUIREMENT IS MET.

COMPACTION: CONSTRUCTION EQUIPMENT SHALL BE OPERATED OVER THE AREAS OR EACH LAYER OF FILL TO INSURE THAT THE REQUIRED COMPACTION IS -EACH LAYER SHALL BE COMPACTED TO OBTAIN 95% OF THE PROTOR VALUE (ASTM 1557 OR AASHTO T180). -FILL ADJACENT TO STRUCTURES, PIPES, ETC SHALL BE COMPACTED TO A DENSITY EQUIVALENT TO THAT OF THE SURROUNDING FILL BY THE MEANS OF HAND TAMPERING OR MANUALLY DIRECTED POWER TAMPER OR PLATE VIBRATORS.


EROSION PROTECTION: A PROTECTIVE COVER OF VEGETATION SHALL BE ESTABLISHED ON ALL EXPOSED SURFACES OF THE EMBANKMENT (CUT/FILL)SLOPE, SPILLWAY, AND BORROW AREA IF SOIL AND CLIMATIC CONDITIONS PERMIT. IF CONDITIONS PRECLUDE THE USE OF VEGETATION AND PROTECTION IS NEEDED, NON-VEGETATION MEANS, SUCH AS EROSION BLANKETS OR RIPRAP SLOPE PROTECTION, MAY BE USED. -SEEDING, FERTILIZING, AND MULCHING SHALL COMPLY WITH THE APPROPRIATE VEGETATIVE BMP'S.

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REVISIONS:					DATE:


CONSTRUCTION DETAILS

PLAN FOR: JASPER'S CORNER HUCKINS ROAD MADBURY, NH

DATE: MARCH, 2014	SCALE: NTS
PROJ. N0: NH-767	SHEET NO. 9 OF 10

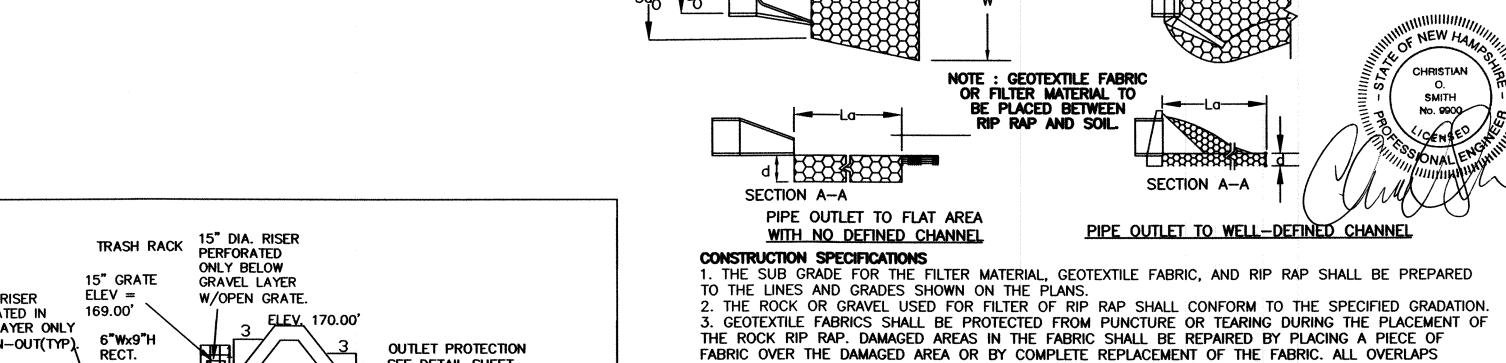


6" DIA. RISER PERFORATED IN STONE LAYER ONLY W/CLEAN-OUT(TYP). SEE DETAIL SHEET ORIFICE ELEV REQUIRED FOR REPAIRS OR JOINING TWO PIECES OF FABRIC SHALL BE A MINIMUM OF 12 INCHES. 4. STONE FOR THE RIP RAP MAY BE PLACED BY EQUIPMENT AND SHALL BE CONSTRUCTED = 168.25'TO THE FULL LAYER THICKNESS IN ONE OPERATION AND IN SUCH A MANNER AS TO PREVENT SEGREGATION OF THE STONE SIZES. 2222 5. STONE FOR RIRAP SHALL BE ANGULAR OR SUBANGULAR. THE STONES SHOULD BE SHAPED SO THAT THE LEAST DIMENSION OF THE STONE FRAGMENT SHALL BE NOT LESS THAN ONE-THIRD OF THE EXISTING GRADE GREATEST DIMENSION OF THE FRAGMENT. 6" UNDERDRAIN' 6. FLAT ROCKS SHALL NOT USED FOR RIP RAP. VOIDS IN THE ROCK RIPRAP SHOULD BE FILLED WITH 15" HDPE-TO 24" RISER AND L = 50.0'; S = 0.014'/'SPALLS AND SMALLER ROCKS. 24" OUTLET INV IN = 166.0'MAINTENANCE CULVERT, ELEV = INV OUT = 165.3' 1. THE OUTLET PROTECTION SHOULD BE CHECKED AT LEAST ANNUALLY AND AFTER EVERY MAJOR STORM. 165.25 IF THE RIP RAP HAS BEEN DISPLACED, UNDERMINED OR DAMAGED, IT SHOULD BE REPAIRED IMMEDIATELY. THE CHANNEL IMMEDIATELY BELOW THE OUTLET SHOULD BE CHECKED TO SEE THAT INSET EROSION IS NOT OCCURRING. THE DOWNSTREAM CHANNEL SHOULD BE KEPT CLEAR OF OBSTRUCTIONS SUCH AS FALLEN TREES, DEBRIS, AND SEDIMENT THAT COULD CHANGE FLOW PATTERNS AND/OR TAILWATER DEPTHS ON THE PIPES. REPAIRS MUST BE CARRIED OUT IMMEDIATELY TO AVOID ADDITIONAL

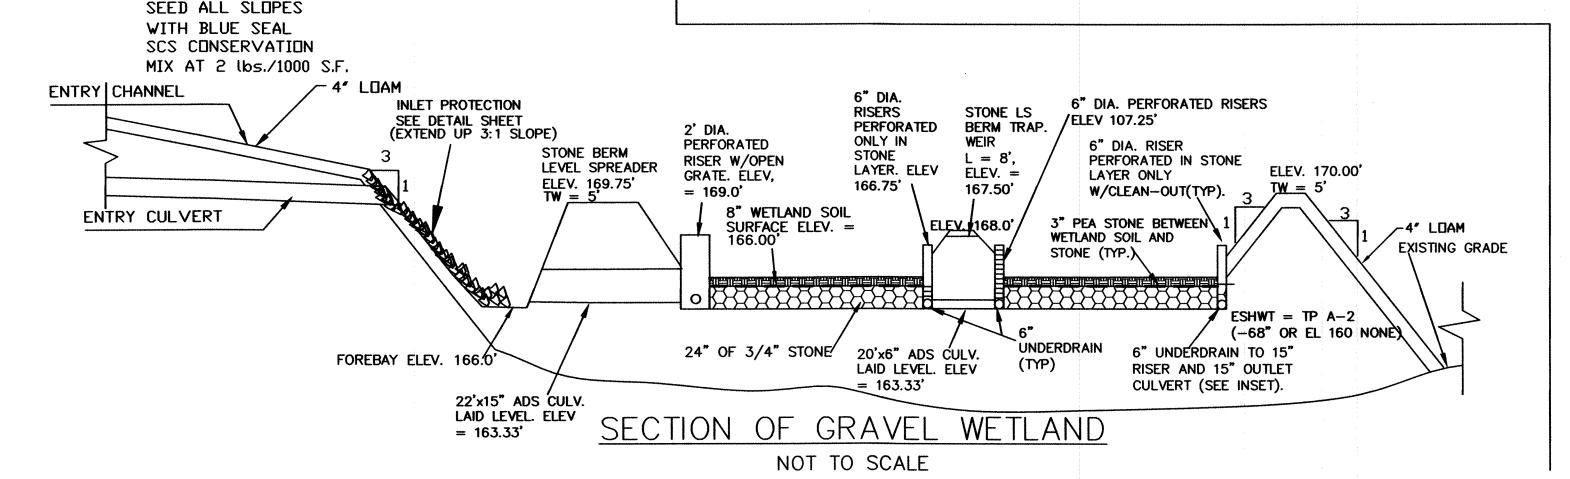

DAMAGE TO OUTLET PROTECTION.

RECOMMENDATIONS.

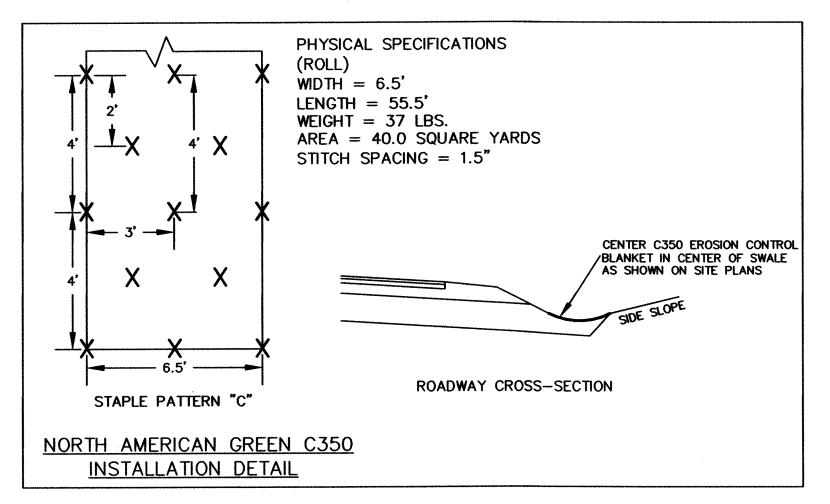

TEMPURARY ERUSION CONTROL MEASURES

1. THE SMALLEST PRACTICAL AREA SHALL BE DISTURBED DURING CONSTRUCTION, BUT NO MORE THAN 5 ACRES OF LAND SHALL BE EXPOSED BEFORE DISTURBED AREAS ARE

2. EROSION, SEDIMENT AND DETENTION MEASURES SHALL BE INSTALLED AS SHOWN ON THE PLANS AND AT LOCATIONS AS REQUIRED OR DIRECTED BY THE ENGINEER ALL DISTURBED AREAS SHALL BE RETURNED TO ORIGINAL GRADES AND ELEVATIONS. 3. DISTURBED AREAS SHALL BE LOAMED WITH A MINIMUM OF 4" OF LOAM AND SEEDED WITH NOT LESS THAN 1.10 POUNDS OF SEED PER 1000 SQUARE FEET OF AREA. (48

POUNDS PER ACRE) SEE SEED SPECIFICATIONS THIS SHEET. 4. SILT FENCES AND OTHER EROSION CONTROLS SHALL BE INSPECTED WEEKLY AND AFTER EVERY RAIN EVENT GREATER THAN 0.5" DURING THE LIFE OF THE PROJECT. ALL DAMAGED AREAS SHALL BE REPAIRED, SEDIMENT DEPOSITS SHALL PERIODICALLY BE REMOVED AND DISPOSED OF.

5. AFTER ALL DISTURBED AREAS HAVE BEEN STABILIZED, THE TEMPORARY EROSION CONTROL MEASURES ARE TO BE REMOVED AND THE AREA DISTURBED BY THE REMOVAL SMOOTHED AND RE-VEGETATED.

6. AREAS MUST BE SEEDED AND MULCHED WITHIN 3 DAYS OF FINAL GRADING, PERMANENTLY STABILIZED WITHIN 15 DAYS OF FINAL GRADING, OR TEMPORARILY

STABILIZED WITHIN 30 DAYS OF INITIAL DISTURBANCE OF SOIL. * AN AREA SHALL BE CONSIDERED STABLE IF ONE OF THE FOLLOWING HAS OCCURRED: - BASE COURSE GRAVELS HAVE BEEN INSTALLED IN AREAS TO BE

 $\boldsymbol{-}$ a minimum of 85% vegetated growth has been established.

- A MINIMUM OF 3 INCHES OF NON-EROSIVE MATERIAL SUCH AS RIPRAP HAS BEEN INSTALLED.

- EROSION CONTROL BLANKETS HAVE BEEN PROPERLY INSTALLED.

CONSTRUCTION SPECIFICATIONS

STRUCTURES SHALL BE INSTALLED ACCORDING TO THE DIMENSIONS SHOWN ON THE PLANS AT THE APPROPRIATE SPACING.

2. CONSTRUCTION OPERATIONS SHALL BE CARRIED OUT IN SUCH A MANNER SO THAT FROSION AND AIR AND WATER POLLUTION WILL BE MINIMIZED.

3. WHEN HAY BALES ARE USED, THE BALES SHALL BE EMBEDDED AT LEAST 4 INCHES INTO THE SOIL. WHEN TIMBER STRUCTURES ARE USED, THE TIMBER SHALL EXTEND AT LEAST 18" INTO THE SOIL.

4. HAY OR STRAW BALES SHALL BE ANCHORED INTO THE SOIL USING 2" X 2" STAKES DRIVEN THROUGH THE BALES AND AT LEAST 18 INCHES IN TO THE SOIL.

5. SEEDING, FERTILIZING, AND MULCHING SHALL CONFORM TO THE RECOMMENDATIONS IN THE APPROPRIATED VEGETATIVE BMP.

6. STRUCTURES SHALL BE REMOVED FROM THE CHANNEL WHEN THEIR USEFUL LIFE HAS BEEN COMPLETED.

7. THROUGHOUT THE DURATION OF CONSTRUCTION ACTIVITIES THE CONTRACTOR SHALL TAKE PRECAUTIONS IN ORDER TO PREVENT. ABATE AND CONTROL THE EMISSION OF FUGITIVE DUST INCLUDING BUT NOT LIMITED TO WETTING, COVERING, SHIELDING, OR VACUUMING.

8. THE NH COMMISSIONER OF AGRICULTURE PROHIBITS THE COLLECTION, POSSESSION, IMPORTATION, TRANSPORTATION, SALE, PROPAGATION, TRANSPLANTATION, OR CULTIVATION OF PLANTS BANNED BY NH LAW RSA 430:53 AND NH CODE ADMINISTRATIVE RULES AGR 3800. THE PROJECT SHALL MEET ALL REQUIREMENTS AND THE INTENT OF RSA 430:53 AND AGR 3800 RELATIVE TO INVASIVE SPECIES.

CONSTRUCTION SEQUENCE

1. CUT AND REMOVE TREES IN CONSTRUCTION AREAS AS REQUIRED OR DIRECTED 2. CONSTRUCT AND/OR INSTALL TEMPORARY AND PERMANENT SEDIMENT EROSION AND DETENTION CONTROL FACILITIES AS REQUIRED. EROSION, SEDIMENT AND DETENTION CONTROL FACILITIES SHALL BE INSTALLED AND STABILIZED PRIOR

TO ANY EARTH MOVING OPERATION AND PRIOR TO DIRECTING RUNOFF TO THEM. 3. CLEAR, CUT, GRUB AND DISPOSE OF DEBRIS IN APPROVED FACILITIES. STUMPS AND DEBRIS ARE TO BE REMOVED FROM SITE AND DISPOSED OF PER STATE AND LOCAL REGULATIONS.

4. EXCAVATE AND STOCKPILE TOPSOIL /LOAM. ALL AREAS SHALL BE STABILIZED IMMEDIATELY AFTER GRADING.

5. CONSTRUCT TEMPORARY CULVERTS AS REQUIRED OR DIRECTED.

6. CONSTRUCT THE ROADWAY/DRIVEWAYS AND ITS ASSOCIATED DRAINAGE STRUCTURES. ALL ROADWAYS, PARKING AREAS, AND CUT/FILL SLOPES SHALL BE STABILIZED AND/OR LOAMED AND SEEDED WITHIN 72-HOURS OF ACHIEVING FINISH GRADE AS APPLICABLE.

7. INSTALL PIPE AND CONSTRUCTION ASSOCIATED APPURTENANCES AS REQUIRED OR DIRECTED. ALL DISTURBED AREAS SHALL STABILIZED IMMEDIATELY AFTER GRADING. 8. BEGIN PERMANENT AND TEMPORARY SEEDING AND MULCHING. ALL CUT AND FILL SLOPES AND DISTURBED AREAS


SHALL BE SEEDED OR MULCHED AS REQUIRED, OR DIRECTED. 9. DAILY OR AS REQUIRED, CONSTRUCT TEMPORARY BERMS, DRAINAGE CHECK DAMS, DITCHES, SEDIMENT TRAPS, ETC.

TO PREVENT EROSION ON THE SITE AND PREVENT ANY SILTATION OF ABUTTING WATERS OR PROPERTY. 10. INSPECT AND MAINTAIN ALL EROSION AND SEDIMENT CONTROL MEASURES DURING CONSTRUCTION

11. COMPLETE PERMANENT SEEDING AND LANDSCAPING 12. REMOVE TEMPORARY EROSION CONTROL MEASURES AFTER SEEDING AREAS HAVE ESTABLISHED THEMSELVES AND SITE IMPROVEMENTS ARE COMPLETE. SMOOTH AND REVEGETATE ALL DISTURBED AREAS.

13. ALL SWALES AND DRAINAGE STRUCTURES WILL BE CONSTRUCTED AND STABILIZED PRIOR TO HAVING RUNOFF DIRECTED TO THEM.

14. FINISH PAVING ALL ROADWAYS/DRIVEWAYS. 15. LOT DISTURBANCE OTHER THAN THAT SHOWN ON THE APPROVED PLANS SHALL NOT COMMENCE UNTIL THE ROADWAY HAS THE BASE COURSE TO DESIGN ELEVATION AND THE ASSOCIATED DRAINAGE IS COMPLETE AND STABLE.

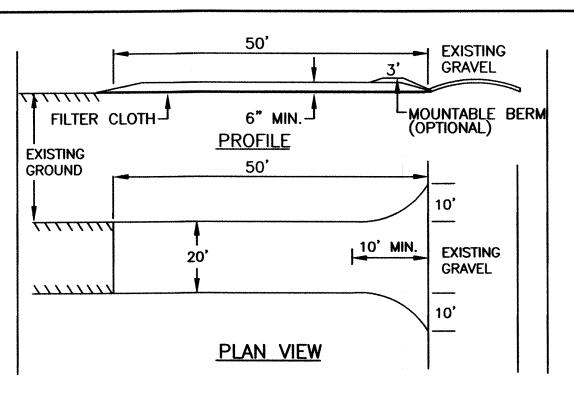

1. STONE FOR A STABILIZED CONSTRUCTION ENTRANCE SHALL BE 1 TO 2 INCH STONE, RECLAIMED STONE, OR RECYCLED CONCRETE EQUIVALENT. 2. THE LENGTH OF THE STABILIZED ENTRANCE SHALL NOT BE LESS THAN 50 FEET, EXCEPT FOR A SINGLE RESIDENTIAL LOT WHERE A 30 FOOT MINIMUM LENGTH WOULD APPLY. 3. THE THICKNESS OF THE STONE FOR THE STABILIZED ENTRANCE SHALL NOT BE LESS THAN 6 INCHES. 4. THE WIDTH OF THE ENTRANCE SHALL NOT BE LESS THAN THE FULL WIDTH OF THE ENTRANCE WHERE INGRESS OR EGRESS OCCURS OR 10 FEET, WHICH EVER IS GREATER. 5. GEOTEXTILE FILTER CLOTH SHALL BE PLACED OVER THE ENTIRE AREA PRIOR TO PLACING THE STONE. FILTER CLOTH IS NOT REQUIRED FOR A SINGLE FAMILY RESIDENCE LOT. 6. ALL SURFACE WATER THAT IS FLOWING TO OR DIVERTED TOWARD THE CONSTRUCTION ENTRANCE SHALL BE PIPED BENEATH THE ENTRANCE. IF PIPING IS IMPRACTICAL, A BERM WITH 5:1 SLOPES THAT CAN BE CROSSED BY VEHICLES MAY BE SUBSTITUTED FOR THE PIPE. 7. THE ENTRANCE SHALL BE MAINTAINED IN A CONDITION THAT WILL PREVENT TRACKING OR FLOWING OF SEDIMENT ONTO PUBLIC RIGHTS-OF-WAY. THIS MAY REQUIRE PERIODIC TOP DRESSING WITH ADDITIONAL STONE AS CONDITIONS DEMAND AND REPAIR AND/OR CLEAN OUT OF ANY MEASURES USED TO TRAP SEDIMENT. ALL SEDIMENT SPILLED, WASHED, OR TRACKED ONTO PUBLIC RIGHT-OF-WAY MUST BE REMOVED

STABILIZED CONSTRUCTION ENTRANCE

WINTER MAINTENANCE

1. ALL DISTURBED AREAS THAT DO NOT HAVE AT LEAST 85% VEGETATIVE COVERAGE PRIOR TO OCTOBER 15TH, SHALL BE STABILIZED BY APPLYING MULCH AT A RATE OF 3-4 TONS PER ACRE. ALL SIDE SLOPES, STEEPER THAN 4:1, THAT ARE NOT DIRECTED TO SWALES OR DETENTION BASINS, SHALL BE LINED WITH BIODEGRADABLE/PHOTODEGRADABLE "JUTE MATTING" (EXCELSIOR'S CURLEX II OR EQUAL). ALL OTHER SLOPES SHALL BE MULCHED AND TACKED AT A RATE OF 3-4 TONS PER ACRE. THE APPLICATION OF MULCH AND/OR JUTE MATTING SHALL NOT OCCUR OVER EXISTING SNOW COVER. IF THE SITE IS ACTIVE AFTER NOVEMBER 15TH, ANY SNOW THAT ACCUMULATES ON DISTURBED AREAS SHALL BE REMOVED. PRIOR TO SPRING THAW ALL AREAS WILL BE STABILIZED, AS DIRECTED ABOVE.

2. ALL SWALES THAT DO NOT HAVE FULLY ESTABLISHED VEGETATION SHALL BE EITHER LINED WITH TEMPORARY JUTE MATTING OR TEMPORARY STONE CHECK DAMS (APPROPRIATELY SPACED). STONE CHECK DAMS WILL BE MAINTAINED THROUGHOUT THE WINTER MONTHS. IF THE SWALES ARE TO BE MATTED WITH PERMANENT LINERS OR RIPRAP WITH ENGINEERING FABRIC, THIS SHALL BE COMPLETED PRIOR TO WINTER SHUTDOWN OR AS SOON AS THEY ARE PROPERLY GRADED AND SHAPED.

3. PRIOR TO NOV. 15TH ALL ROADWAY AND PARKING AREAS SHALL BE BROUGHT UP TO AND THROUGH THE BANK RUN GRAVEL APPLICATION. IF THESE AREAS' ELEVATIONS ARE PROPOSED TO REMAIN BELOW THE PROPOSED SUBGRADE ELEVATION. THE SUBGRADE MATERIAL SHALL BE ROUGHLY CROWNED AND A 3" LAYER OF CRUSHED GRAVEL SHALL BE PLACED AND COMPACTED. THIS WILL ALLOW THE SUBGRADE TO SHED RUNOFF AND WILL REDUCE ROADWAY EROSION. THIS CRUSHED GRAVEL DOES NOT HAVE TO CONFORM TO NH DOT 304.3, BUT SHALL HAVE BETWEEN 15-25% PASSING THE #200 SIEVE AND THE LARGEST STONE SIZE SHALL BE 2". IF THE SITE IS ACTIVE AFTER NOVEMBER 15TH, ANY ACCUMULATED SNOW SHALL BE REMOVED FROM ALL ROADWAY AND PARKING AREAS.

4. AFTER OCTOBER 15TH, THE END OF NEW HAMPSHIRE'S AVERAGE GROWING SEASON, NO ADDITIONAL LOAM SHALL BE SPREAD ON SIDE SLOPES AND SWALES. THE STOCKPILES THAT WILL BE LEFT UNDISTURBED UNTIL SPRING SHALL BE SEEDED BY THIS DATE. AFTER OCTOBER 15TH, ANY NEW OR DISTURBED PILES SHALL BE MULCHED AT A RATE OF 3-4 TONS PER ACRE. ALL STOCKPILES THAT WILL REMAIN THROUGHOUT THE WINTER SHALL BE SURROUNDED WITH SILT

SEEDING SPECIFICATIONS

1. GRADING AND SHAPING

A. SLOPES SHALL NOT BE STEEPER THAN 2:1;3:1 SLOPES OR FLATTER ARE PREFERRED. WHERE MOWING WILL BE DONE, 3:1 SLOPES OR FLATTER ARE RECOMMENDED.

2. SEEDBED PREPARATION

A. SURFACE AND SEEPAGE WATER SHOULD BE DRAINED OR DIVERTED FROM THE SITE TO PREVENT DROWNING OR WINTER

KILLING OF THE PLANTS. B. STONES LARGER THAN 4 INCHES AND TRASH SHOULD BE REMOVED BECAUSE THEY INTERFERE WITH SEEDING AND FUTURE MAINTENANCE OF THE AREA. WHERE FEASIBLE, THE SOIL SHOULD BE TILLED TO A DEPTH OF ABOUT 4 INCHES TO PREPARE A SEEDRED AND MIX FERTILIZER AND LIME INTO THE SOIL. THE SEEDRED SHOULD BE LEFT IN REASONABLY FIRM AND SMOOTH CONDITION. THE LAST TILLAGE OPERATION SHOULD BE PERFORMED ACROSS THE SLOPE WHEREVER PRACTICAL.

3. ESTABLISHING A STAND

A. LIME AND FERTILIZER SHOULD BE APPLIED PRIOR TO OR AT THE TIME OF SEEDING AND INCORPORATED INTO THE SOIL KINDS AND AMOUNTS OF LIME AND FERTILIZER SHOULD BE BASED ON AN EVALUATION OF SOIL TESTS. WHEN A SOIL TEST IS NOT AVAILABLE, THE FOLLOWING MINIMUM AMOUNTS SHOULD BE APPLIED: AGRICULTURAL LIMESTONE, 2 TONS PER ACRE OR 100 LBS PER 1,000 SQ. FT..

NITROGEN(N), 50 LBS PER ACRE OR 1. 1 LBS PER 1,000 SQ.FT.

PHOSPHATE(P205), 100 LBS PER ACRE OR 2. 2 LBS PER 1,000 SQ.FT.

POTASH(K2O), 100 LBS PER ACRE OR 2. 2 LBS PER 1,000 SQ.FT.

(NOTE: THIS IS THE EQUIVALENT OF 500 LBS PER ACRE OF 10-20-20 FERTILIZER OR 1,000 LBS PER ACRE OF 5-10-10.)

B. SEED SHOULD BE SPREAD UNIFORMLY BY THE METHOD MOST APPROPRIATE FOR THE SITE. METHODS INCLUDE BROADCASTING, DRILLING AND HYDROSEEDING, WHERE BROADCASTING IS USED, COVER SEED WITH .25 INCH OF SOIL OR LESS, BY CULTIPACKING OR RAKING.

C. REFER TO TABLE(G-E1 THIS SHEET) FOR APPROPRIATE SEED MIXTURES AND TABLE(H-E1 THIS SHEET) FOR RATES OF SEEDING. ALL LEGUMES (CROWN VETCH, BIRDS FOOT TREFOIL, AND FLAT PEA) MUST BE INOCULATED WITH THEIR SPECIFIC INOCULANT.

D. WHEN SEEDED AREAS ARE MULCHED, PLANTINGS MAY BE MADE FROM EARLY SPRING TO EARLY OCTOBER. WHEN SEEDED AREAS ARE NOT MULCHED, PLANTINGS SHOULD BE MADE FROM EARLY SPRING TO MAY 20 OR FROM AUGUST 10 TO SEPTEMBER 1.

4. MULCH

A. HAY, STRAW, OR OTHER MULCH, WHEN NEEDED, SHOULD BE APPLIED IMMEDIATELY AFTER SEEDING.

B. MULCH WILL BE HELD IN PLACE USING APPROPRIATE TECHNIQUES FROM THE BEST MANAGEMENT PRACTICE FOR MULCHING. HAY OR STRAW MULCH SHALL BE PLACED AT A RATE OF 90 LBS PER 1000 SQ. FT.

5. MAINTENANCE TO ESTABLISH A STAND


A. PLANTED AREA SHOULD BE PROTECTED FROM DAMAGE BY FIRE, GRAZING, TRAFFIC, AND DENSE WEED GROWTH. B. FERTILIZATION NEEDS SHOULD BE DETERMINED BY ONSITE INSPECTIONS. SUPPLEMENTAL FERTILIZER IS USUALLY THE KEY TO FULLY COMPLETE THE ESTABLISHMENT OF THE STAND BECAUSE MOST PERENNIAL STAKE 2 TO 3 YEARS TO BECOME ESTABLISHED.

C. IN WATERWAYS, CHANNELS, OR SWALES WHERE UNIFORM FLOW CONDITIONS ARE ANTICIPATED, OCCASIONAL MOWING MAY BE NECESSARY TO CONTROL GROWTH OF WOODY VEGETATION.

KEY STONE INTO CHANNEL BANKS AND EXTEND BEYOND ABUTMENTS A MINIMUM OF 18" TO PREVENT FLOW AROUND THE DAM. L= THE DISTANCE SUCH THAT POINTS A AND B ARE OF EQUAL ELEVATION. SPACING BETWEEN STRUCTURES

TEMPORARY GRADE STABILIZATION STRUCTURES SHOULD BE CHECKED AFTER EACH RAINFALL AND AT LEAST DAILY DURING PROLONGED STORMS. ANY NECESSARY REPAIRS SHOULD BE MADE IMMEDIATELY. PARTICULAR ATTENTION SHOULD BE GIVEN TO END RUN AND EROSION AT THE DOWNSTREAM TOE OF THE STRUCTURE. WHEN THE STRUCTURES ARE REMOVED, THE DISTURBED PORTION SHOULD BE BROUGHT TO THE EXISTING CHANNEL GRADE AND THE AREAS PREPARED, SEEDED AND MULCHED. WHILE THIS PRACTICE IS NOT INTENDED TO BE USED PRIMARILY FOR SEDIMENT TRAPPING, SOME SEDIMENT WILL ACCUMULATE BEHIND THE STRUCTURES. SEDIMENT SHALL BE REMOVED FROM BEHIND THE STRUCTURES WHEN IT HAS ACCUMULATED TO ONE HALF OF THE ORIGINAL HEIGHT OF THE STRUCTURE.

AFTER VEGETATION HAS STABILIZED, THESE TEMPORARY STRUCTURES SHALL BE REMOVED WITH SPECIAL CARE AS TO AVOID DISTURBING ANY UNDERLYING EROSION CONTROL FABRIC AND/OR EXISTING VEGETATION

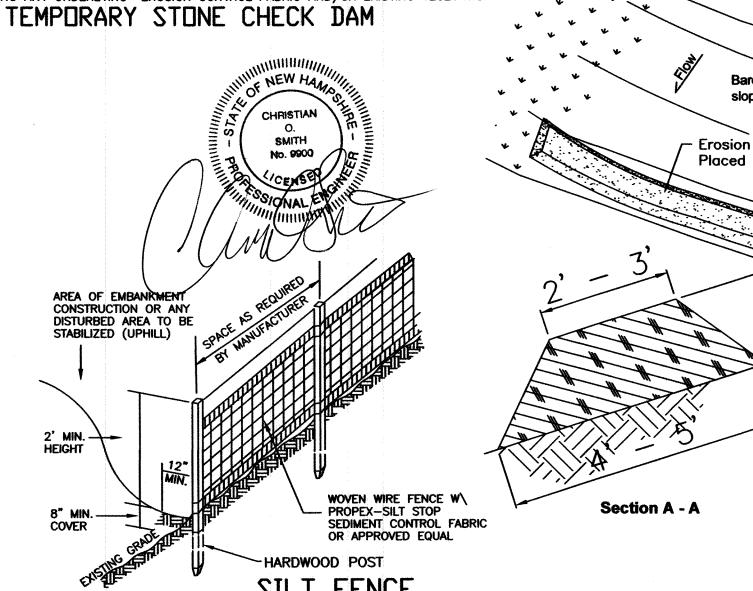

CONSTRUCTION SPECIFICATIONS 1. WOVEN WIRE FENCE TO BE FASTENED SECURELY TO FENCE POSTS WITH WIRE TIES OR STAPLES AND FILTER CLOTH SHALL BE FASTENED TO WOVEN WIRE EVERY 24" AT TOP MID AND BOTTOM SECTIONS AND BE EMBEDDED INTO GROUND A MINIMUM OF 8". 2. THE FENCE POSTS SHALL BE A MINIMUM 48" LONG, SPACED A MAXIMUM 10' APART, AND DRIVEN A MINIMUM OF 16" INTO THE GROUND.

3. WHEN TWO SECTIONS OF FILTER CLOTH ADJOIN EACH OTHER, THE ENDS OF THE FABRIC SHALL BE OVERLAPPED BY SIX INCHES, FOLDED AND STAPLED TO PREVENT SEDIMENT FROM 4. MAINTENANCE SHALL BE PERFORMED AS NEEDED AND SEDIMENT REMOVED WHEN "BULGES"

DEVELOP IN THE SILT FENCE AND PROPERLY DISPOSED OF. 5. PLACE THE ENDS OF THE SILT FENCE UP CONTOUR TO PROVIDE FOR SEDIMENT STORAGE. 6. SILT FENCES SHALL BE REMOVED WHEN NO LONGER NEEDED AND THE SEDIMENT COLLECTED SHALL BE DISPOSED AS DIRECTED BY THE ENGINEER. THE AREA DISTURBED BY THE REMOVAL SHALL BE SMOOTHED AND RE-VEGETATED


MAINTENANCE

1. SILT FENCES SHALL BE INSPECTED IMMEDIATELY AFTER EACH RAINFALL AND AT LEAST DAILY DURING PROLONGED RAINFALL, ANY REPAIRS THAT ARE REQUIRED SHALL BE MADE IMMEDIATELY.

2. IF THE FABRIC ON A SILT FENCE SHOULD DECOMPOSE OR BECOME INEFFECTIVE DURING THE EXPECTED LIFE OF THE FENCE, THE FABRIC SHALL BE REPLACED PROMPTLY. 3. SEDIMENT DEPOSITS SHOULD BE INSPECTED AFTER EVERY STORM EVENT. THE DEPOSITS SHOULD BE REMOVED WHEN THEY REACH APPROXIMATELY ONE HALF THE HEIGHT OF THE

4. SEDIMENT DEPOSITS THAT ARE REMOVED OR LEFT IN PLACE AFTER THE FABRIC HAS BEEN REMOVED SHALL BE GRADED TO CONFORM WITH THE EXISTING TOPOGRAPHY AND VEGETATED.

SEEDING GUIDE

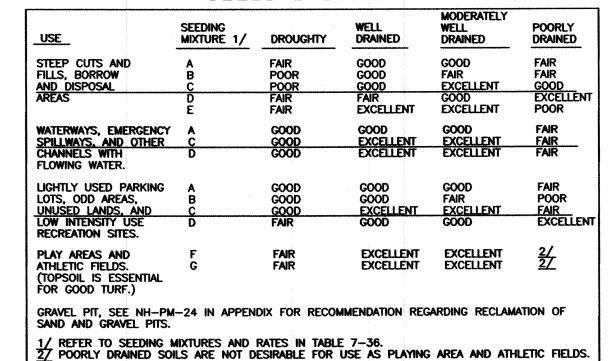

NOTE: TEMPORARY SEED MIX FOR STABILIZATION OF TURF SHALL BE WINTER RYE OR DATS AT A RATE OF 2.5 LBS. PER 1000 S.F. AND SHALL BE PLACED PRIOR TO OCT. 15, IF PERMANENT SEEDING NOT YET COMPLETE.

PREPARED FOR: ONE HOME BUILDERS, LLC PO BOX 334

BEALS · ASSOCIATES PLLC

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Erosion Control Mix Be Mix material should consist of 30+50% large (1-3") particles. The organic matter content should be 25%-65%, dry weight basis. The organic matter may originate from a variety of vegetative sources, but needs to be fibrous and elongated. The mix shall be free of sil clay, fine sand, refuse and contaminants or any material toxic to plant growth. Erosion Control Mix berms are effective filters for overland flow conditions and should not be used to filter concentrated flow such as that found in drainage ditchs, streams, etc.

Erosion Control Mix Berm

SEEDING RATES POUNDS PER 1.000 Sq. Ft PER ACRE MIXTURE A. TALL FESCUE CREEPING RED FESCUE B. TALL FESCUE CREEPING RED FESCUE CROWN VETCH 40 OR 55 CREEPING RED FESCUE BIRDS FOOT TREFOIL D. TALL FESCUE FLAT PEA e. Creeping red fescue 🔟 KENTUCKY BLUEGRASS F. TALL FESCUE 1 1/ FOR HEAVY USE ATHLETIC FIELDS CONSULT THE UNIVERSITY NEW HAMPSHIRE COOPERATIVE EXTENSION TURF SPECIALIST FOR CURRENT VARIETIES AND SEEDING RATES.

REVISED PER REVIEW COMMENTS 4/25/14 DATE: **REVISIONS:**

EROSION CONTROL DETAILS

PLAN FOR: JASPER'S CORNER HUCKINS ROAD MADBURY, NH

DATE: MARCH, 2014	SCALE: NTS	
PROJ. N0: NH-767	SHEET NO. 10 OF 10	